

LEGEND AND GENERAL NOTES

LEGEND, GENERAL NOTES AND ABBREVIATIONS SHALL APPLY TO ALL SHEETS UNLESS OTHERWISE NOTED ON INDIVIDUAL SHEET

LEGEND

EXISTING		NEW		EXISTING		NEW	
	500 INDEX CONTOUR		500 INDEX CONTOUR		TREE		TREE
	INTERMEDIATE CONTOUR		498 INDEX CONTOUR		TREELINE		TREELINE
	RIGHT-OF-WAY		R/W		LIGHT		LIGHT
	LOT LINE		R/W		COBRAHEAD LIGHT		COBRAHEAD LIGHT
	PERMANENT EASEMENT		PE		LOAD CENTER		LOAD CENTER
	AERIAL ELECTRIC		AE		HAND HOLE		HAND HOLE
	UTILITY POLE		UTILITY POLE		MAILBOX		MAILBOX
	GUY WIRE		GUY WIRE		SIGN		SIGN
	UNDERGROUND ELECTRIC		UGE		CORING LOCATION		CORING LOCATION
	UNDERGROUND CABLE TV		CATV		CONCRETE PAVEMENT		CONCRETE PAVEMENT
	UNDERGROUND TELEPHONE		UGT		ASPHALT PAVEMENT		ASPHALT PAVEMENT
	UNDERGROUND FIBER OPTIC		FO		GRAVEL SURFACE		GRAVEL SURFACE
	SANITARY SEWER LINE		SAN		ROCK BLANKET/DITCH LINER		ROCK BLANKET/DITCH LINER
	SANITARY FORCEMAIN		FM		CONCRETE APPROACH		CONCRETE APPROACH
	SANITARY SEWER MANHOLE		SANITARY SEWER MANHOLE		CONCRETE SIDEWALK		CONCRETE SIDEWALK
	STORM SEWER LINE		STORM SEWER LINE		CURB RAMP		CURB RAMP
	STORM SEWER MANHOLE		STORM SEWER MANHOLE		ASPHALT DRIVEWAY		ASPHALT DRIVEWAY
	CURB/AREA INLET		CURB/AREA INLET		AGGREGATE DRIVEWAY		AGGREGATE DRIVEWAY
	GRATED INLET		GRATED INLET		SODDING		SODDING
	GRATED INLET W/ SIDE INTAKE		GRATED INLET W/ SIDE INTAKE		FULL DEPTH PAVEMENT (WIDENING)		FULL DEPTH PAVEMENT (WIDENING)
	FLARED END SECTION		FLARED END SECTION		FULL DEPTH PAVEMENT (REPAIR)		FULL DEPTH PAVEMENT (REPAIR)
	SWALE		SWALE		PAVEMENT MILLING		PAVEMENT MILLING
	GAS LINE		GAS LINE		RETAINING WALL		RETAINING WALL
	GAS VALVE		GAS VALVE		CONCRETE VERTICAL CURB		CONCRETE VERTICAL CURB
	GAS METER		GAS METER		CONCRETE CURB AND GUTTER		CONCRETE CURB AND GUTTER
	WATER LINE		WATER LINE		CONSTRUCTION LIMITS		CONSTRUCTION LIMITS
	FIRE HYDRANT		FIRE HYDRANT		SILT FENCE		SILT FENCE
	WATER VALVE		WATER VALVE		INLET CHECK		INLET CHECK
	WATER METER		WATER METER		DITCH CHECK		DITCH CHECK
	GUARDRAIL		GUARDRAIL		PROJECT BASELINE		PROJECT BASELINE
	FENCE		FENCE		TEMPORARY CONSTRUCTION EASEMENT		TEMPORARY CONSTRUCTION EASEMENT

ABBREVIATIONS

AI - AREA INLET	MIN - MINIMUM	∅ - DIAMETER
ARC - ARC LENGTH	NO - NUMBER	CL - CENTERLINE
ATG - ADJUST TO GRADE	O/S - OFFSET	(1) - KEYED NOTE
BF - BOTTOM OF FOOTING	OC - ON CENTER	
BOP - BEGINNING OF PAVEMENT	PC - POINT OF CURVATURE	
BW - BOTTOM OF WALL	PCC - POINT OF COMPOUND CURVATURE	
CB - CHORD BEARING	PE - PERMANENT EASEMENT	
CHD - CHORD LENGTH	PI - POINT OF INTERSECTION	
CI - CURB INLET	PRC - POINT OF REVERSE CURVATURE	
CMP - CORRUGATED METAL PIPE	PT - POINT OF TANGENCY	
DCI - DOUBLE CURB INLET	R/W - RIGHT-OF-WAY	
DGI - DOUBLE GRATED INLET	RAD - RADIUS	
ELEV - ELEVATION	RCP - REINFORCED CONCRETE PIPE	
EOP - END OF PAVEMENT	RT - RIGHT	
FES - FLARED END SECTION	SSD - STOPPING SIGHT DISTANCE	
FL - FLOW LINE	STA - STATION	
GI - GRATED INLET	TBR - TO BE REMOVED	
GIS - GRATED INLET WITH SIDE INTAKE	TBR&R - TO BE REMOVED AND REPLACED	
HDPE - HIGH-DENSITY POLYETHYLENE	TCE - TEMPORARY CONSTRUCTION EASEMENT	
JB - JUNCTION BOX	TW - TOP OF WALL	
LF - LINEAR FEET	TYP - TYPICAL	
LT - LEFT	VPC - VERTICAL POINT OF CURVATURE	
MAX - MAXIMUM	VPI - VERTICAL POINT OF INTERSECTION	
MH - MANHOLE	VPT - VERTICAL POINT OF TANGENCY	

GENERAL NOTES

TOPOGRAPHIC SURVEY NOTES:

1.

DESIGN NOTES:

- CONTRACTOR SHALL RELOCATE ALL EXISTING SIGNS, PLANTERS, MAILBOXES, AND PRIVATE LIGHTS AS NECESSARY FOR THE CONSTRUCTION OF THE IMPROVEMENTS. NEW LOCATIONS SHALL BE AS DIRECTED BY THE ENGINEER.
- CONTRACTOR SHALL ADJUST TO GRADE ALL UTILITIES NECESSARY TO BRING THE UTILITY TO THE GRADE OF THE NEW CONSTRUCTION.
- CONTRACTOR SHALL FIELD VERIFY THE LOCATION AND ELEVATION OF ALL POTENTIAL UTILITY CONFLICTS PRIOR TO ORDERING STORM SEWER PIPE AND STRUCTURES.
- CONTRACTOR SHALL REMOVE AND REPLACE ALL EXISTING PRIVATE SIDEWALKS AS NECESSARY FOR THE CONSTRUCTION OF THE IMPROVEMENTS. PRIVATE SIDEWALKS SHALL BE SAW CUT AT THE RIGHT-OF-WAY OR NEAREST JOINT AS DIRECTED BY THE ENGINEER.
- EXISTING CULVERT PIPES, WHICH ARE UNDER DRIVEWAYS BEING REPLACED BY THE CONSTRUCTION OF IMPROVEMENTS, SHALL BE REMOVED.
- CONTRACTOR SHALL DISCUSS MILLING DEPTHS WITH THE ENGINEER PRIOR TO STARTING THE MILLING PROCESS. DEPTH SHOWN IS APPROXIMATE AND MAY VARY AS DIRECTED TO OBTAIN THE DESIRED CROSS SLOPE AND PROFILE. UNIT COST FOR THE MILLING WORK SHALL NOT CHANGE REGARDLESS OF THE MILLED THICKNESS, UNLESS THE BID FORM PROVIDES MULTIPLE MILLING DEPTH LINE ITEMS.
- OBLITERATE ANY EXISTING STRIPING THAT CONFLICTS WITH THE PROPOSED PAVEMENT MARKING PLAN. THE PROCESS FOR REMOVAL SHALL BE APPROVED BY THE ENGINEER PRIOR TO BEGINNING (INCIDENTAL TO CONSTRUCTION).
- THE LOCATION OF THE NEW UNDERGROUND ELECTRIC FOR STREET LIGHTING AS SHOWN IS APPROXIMATE AND SHALL NOT INTERFERE WITH ANY NEW OR EXISTING UTILITIES, SIGNS, TREES, OR IMPROVEMENTS OF ANY KIND. THEREFORE, THE CONTRACTOR SHALL COORDINATE THE INSTALLATION OF UNDERGROUND ELECTRIC WITH EXISTING UTILITIES AND ANY OTHER IMPROVEMENTS ASSOCIATED WITH THIS PROJECT.
- ALL AREAS OF CLEARING, GRUBBING AND STRIPPING NOT SHOWN IN PLANS, CONTRACTOR SHALL CONDUCT CLEARING, GRUBBING AND STRIPPING AS NECESSARY UNLESS OTHERWISE NOTED IN PLANS.

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LAND SURVEYING CERTIFICATE OF AUTHORITY NUMBER - 2007004629



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RIES ROAD IMPROVEMENTS
FEDERAL PROJECT NO. STP-4939(610)
CITY OF BALLWIN, MISSOURI

LEGEND AND GENERAL NOTES	
DATE:	10/6/23
DWN. BY:	M.D.M.
APPD. BY:	K.J.W.
SCALE:	NO SCALE
PROJ. NO.:	SC19-1061
DWG. NO.:	LG-1

SITE PLAN



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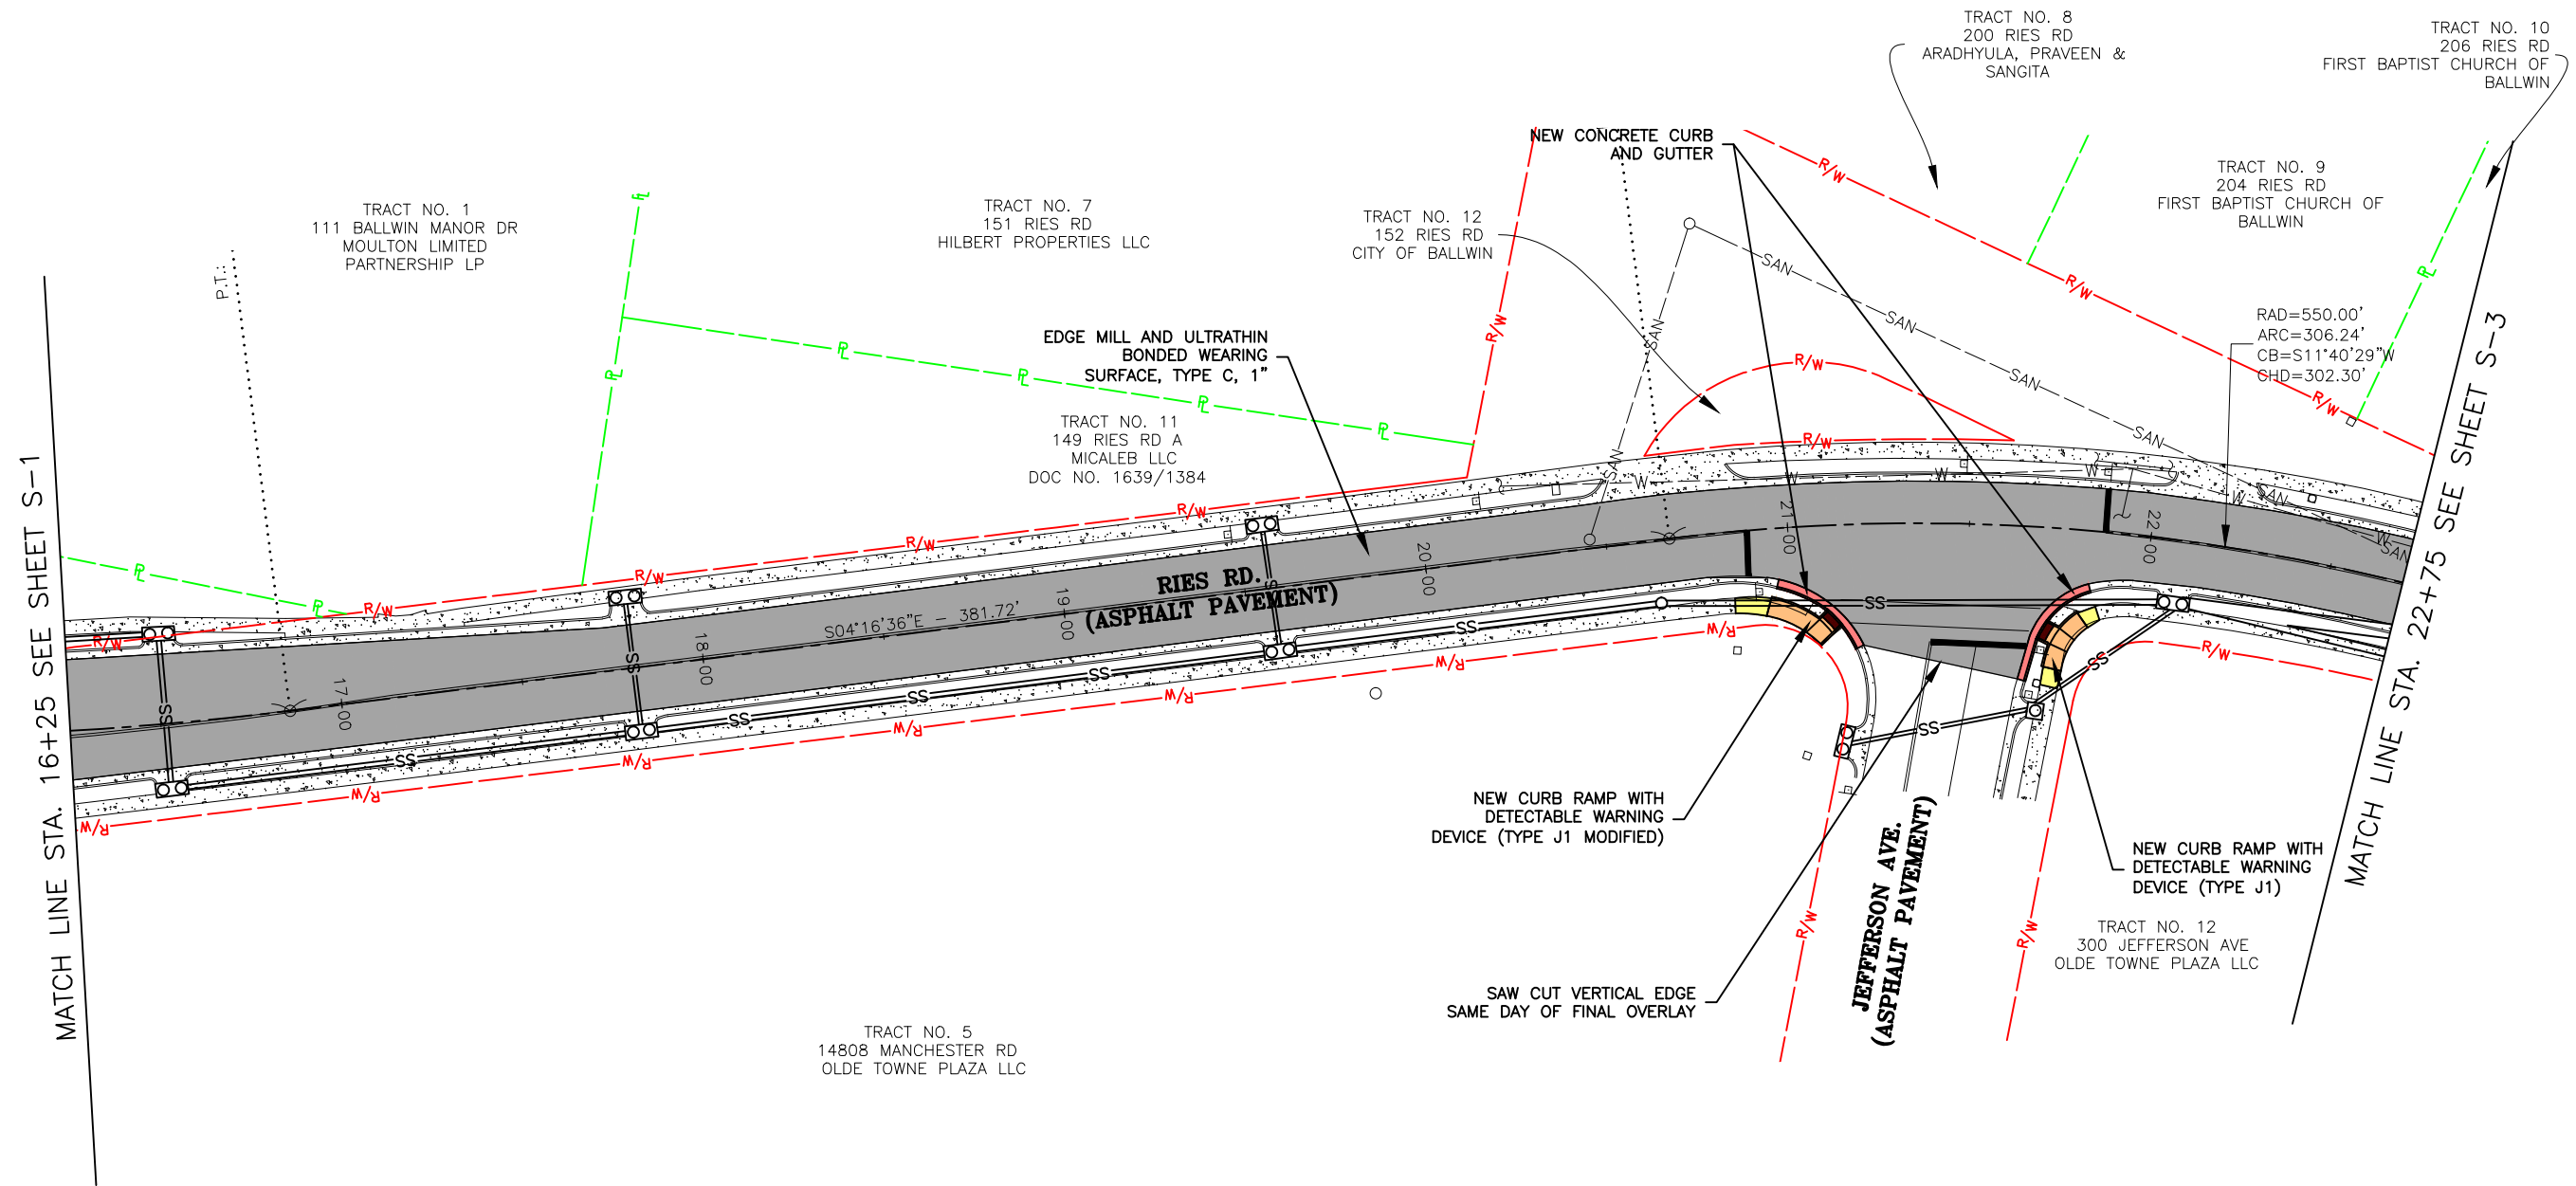
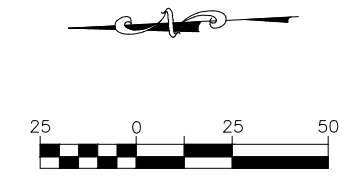
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DWN. BY: M.D.M.	APPD. BY: K.J.W.
DATE: 10/6/23	
SCALE: 1" = 50'	
PROJ. NO: SC19-1061	
DWG. NO: S-1	

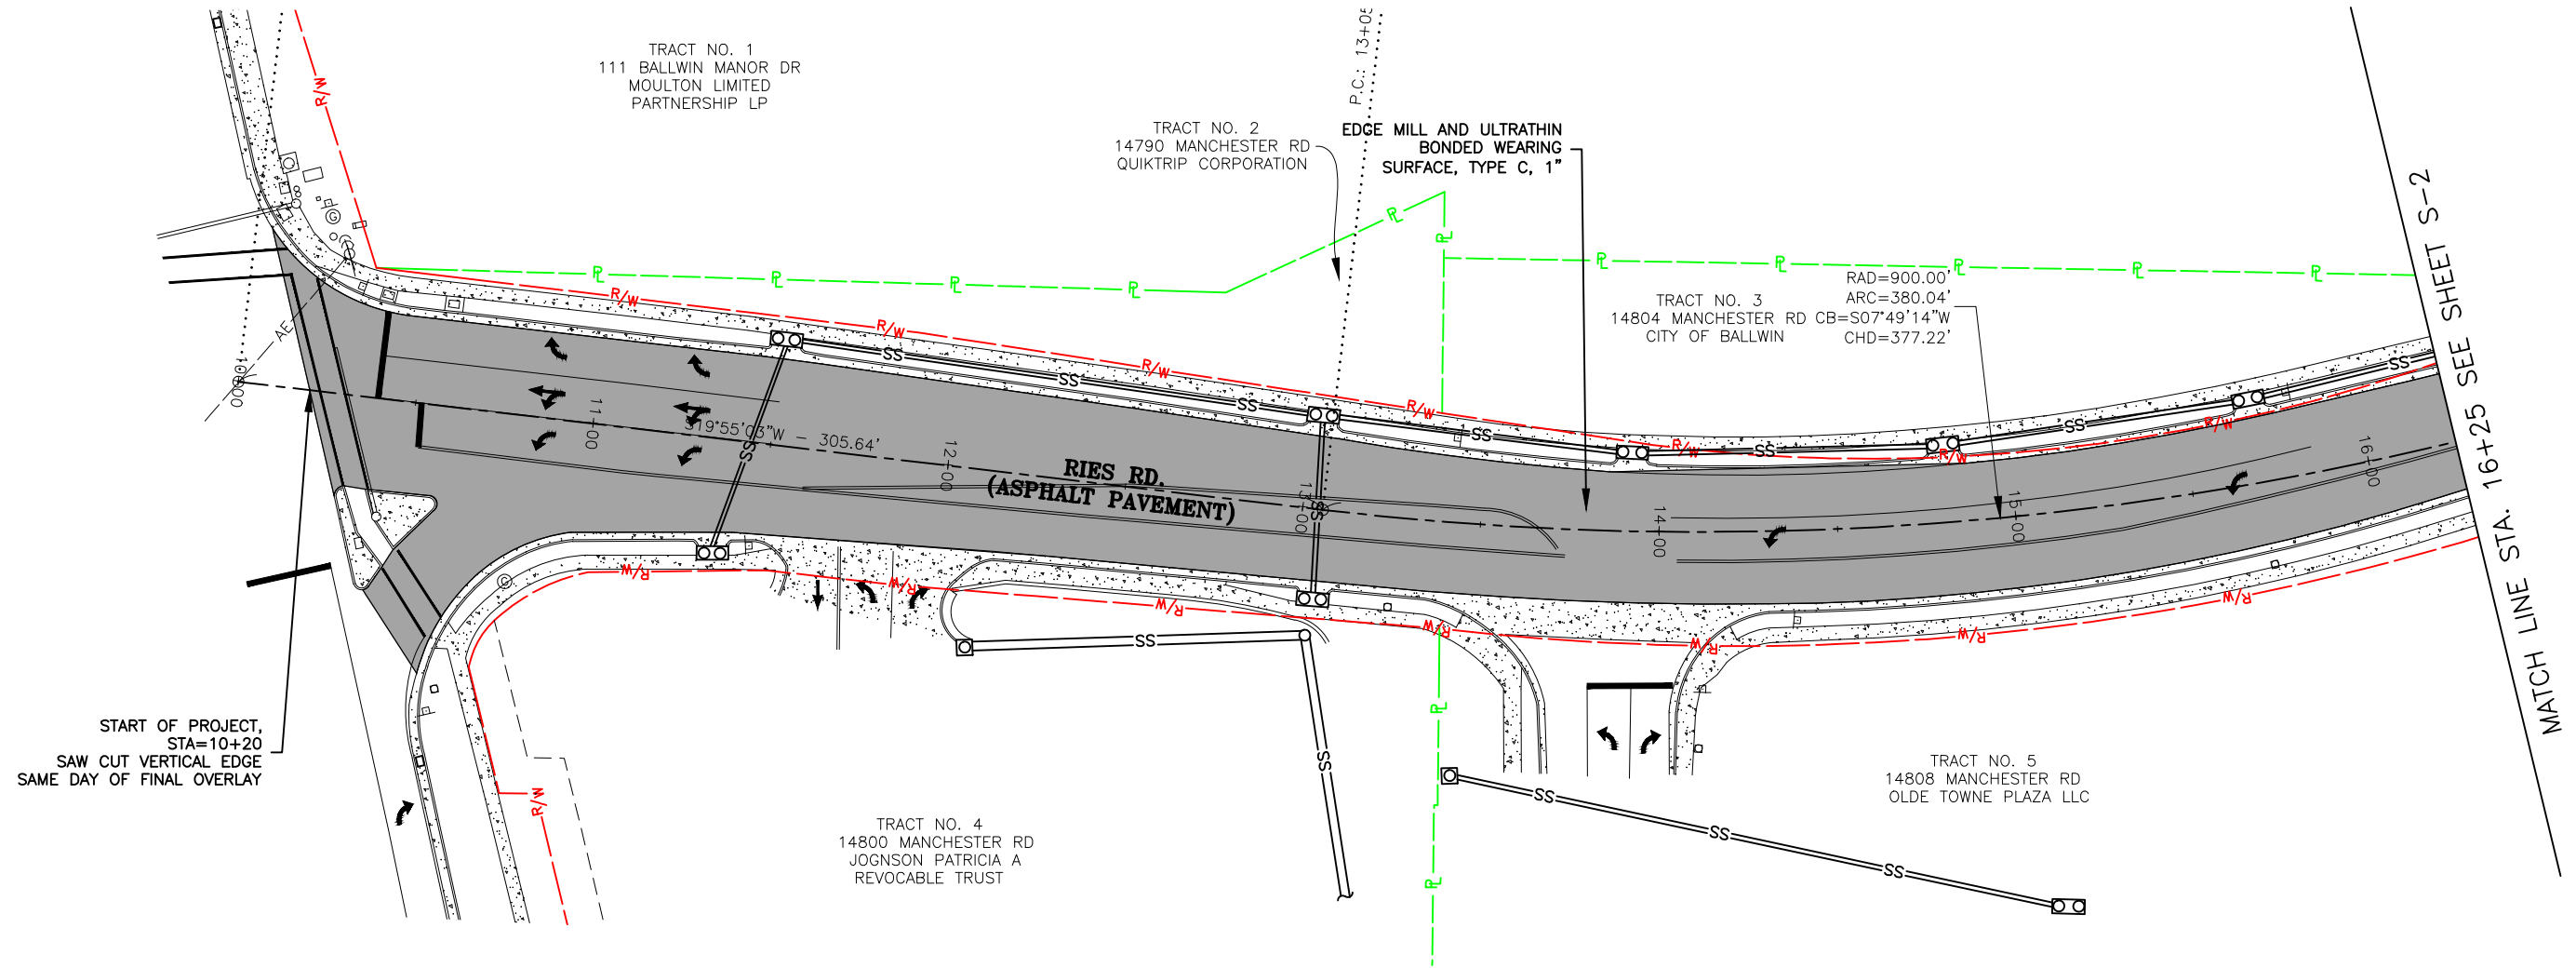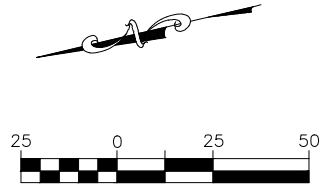Drawing name: U:\SC19-1061 Ballwin Ries Road\AUTOCAD DRAWINGS\SITE PLAN.dwg Tab: S-1 Plotted on: Oct 18, 2023 - 10:36am Plotted by: MSPalding

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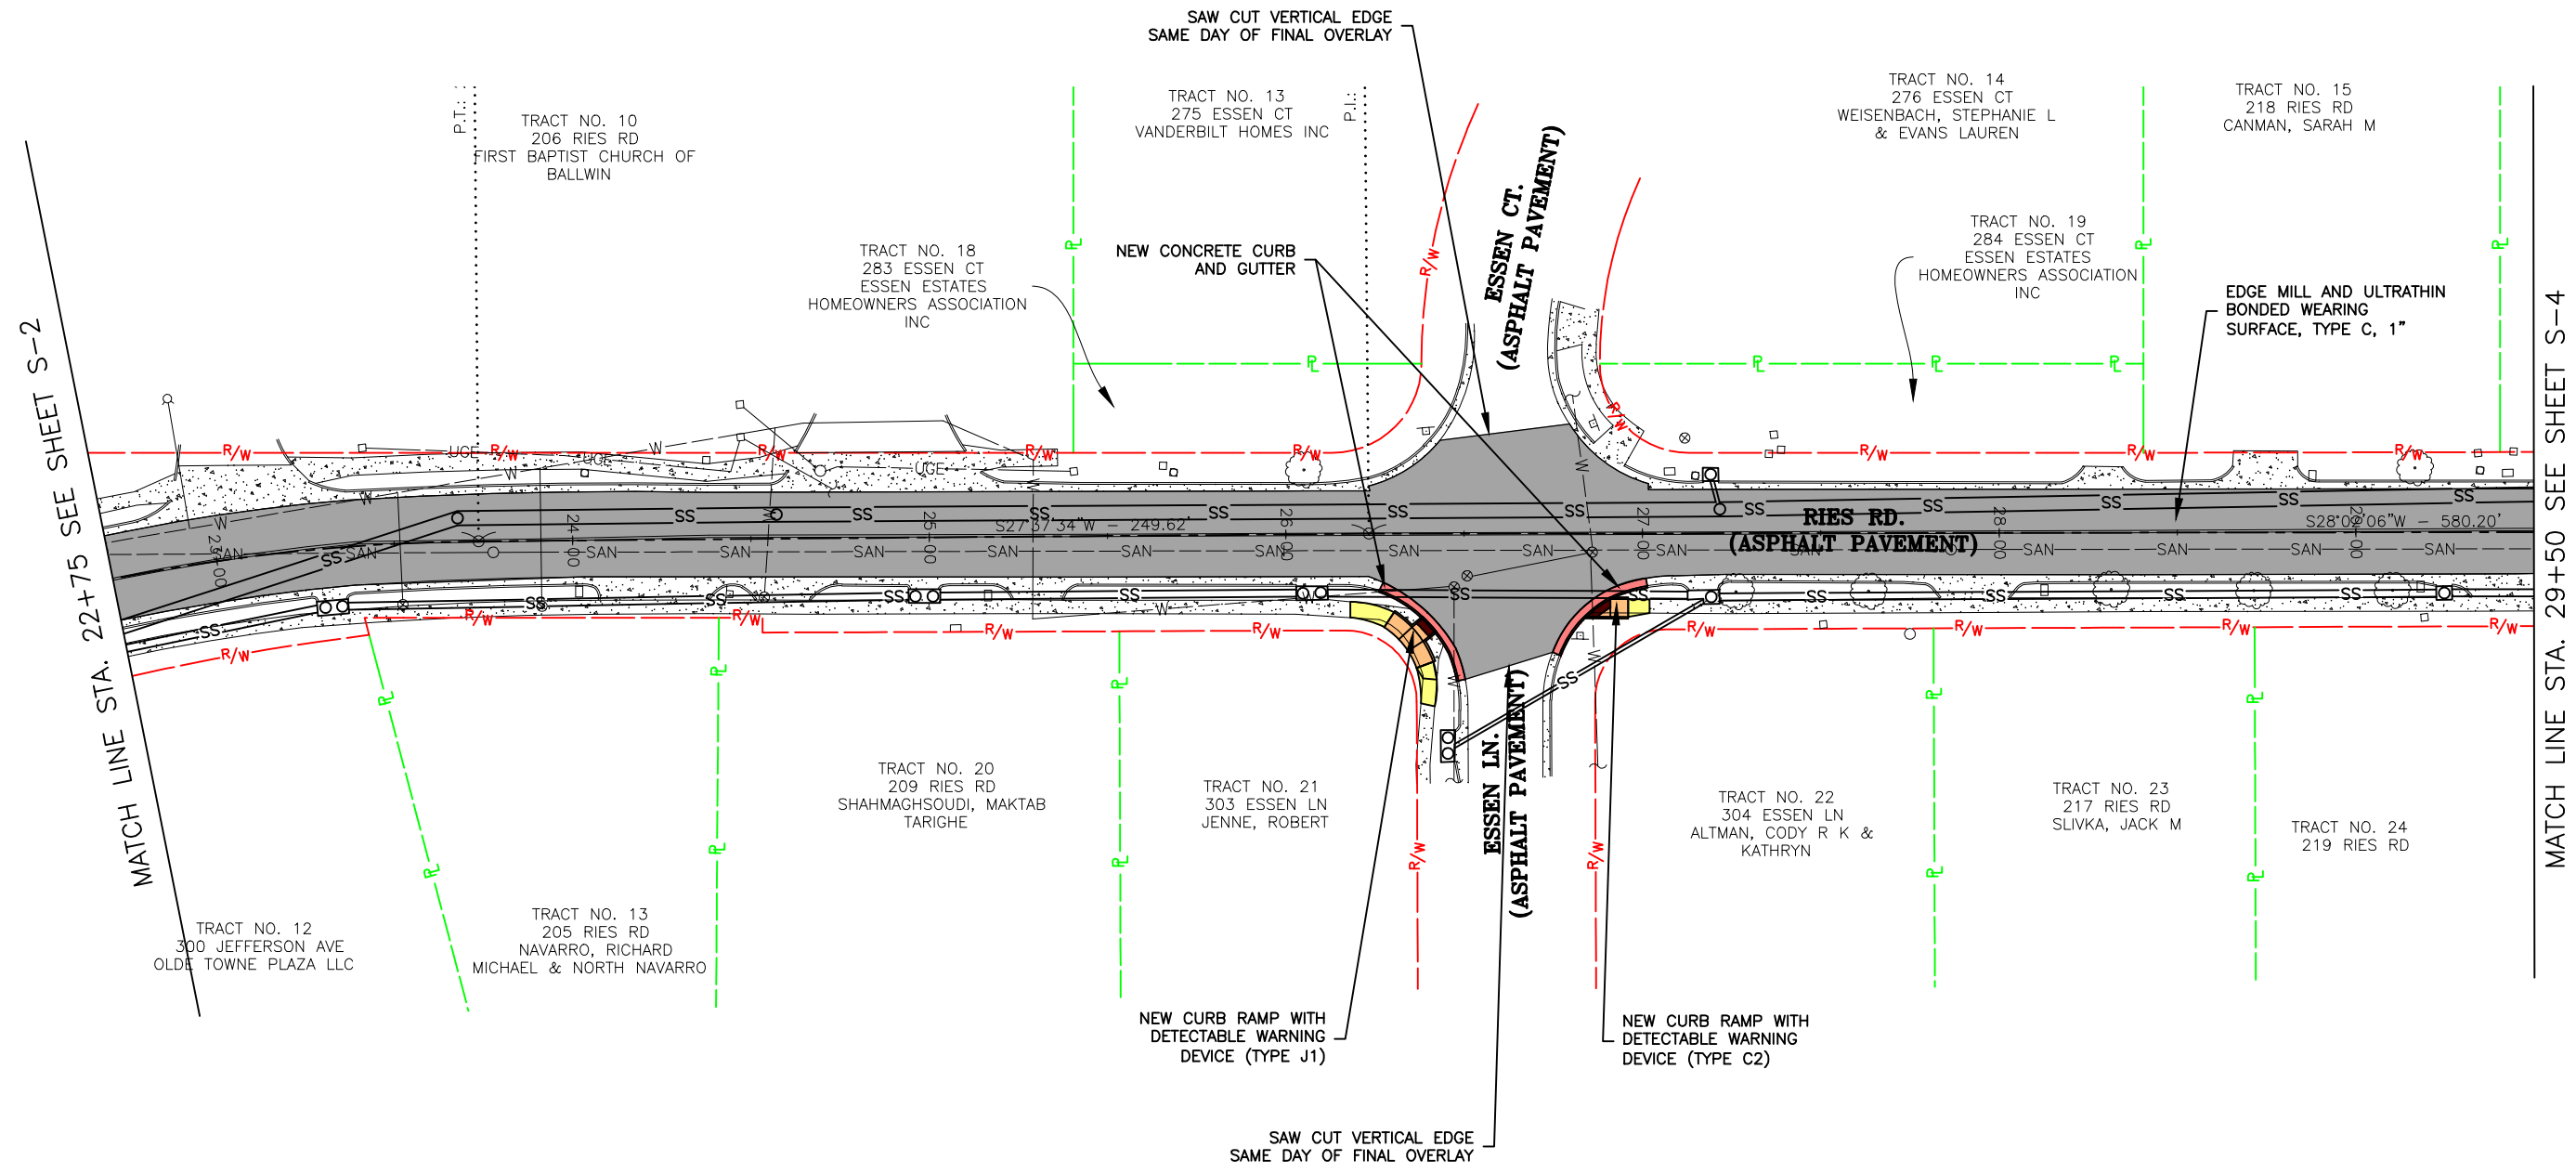
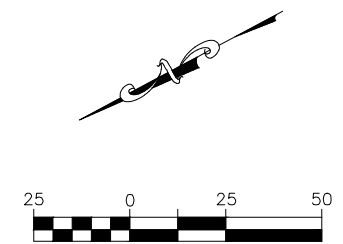
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DWG. NO: S-2	

SITE PLAN



MATCH LINE STA. 22+75 SEE SHEET S-2

MATCH LINE STA. 29+50 SEE SHEET S-4

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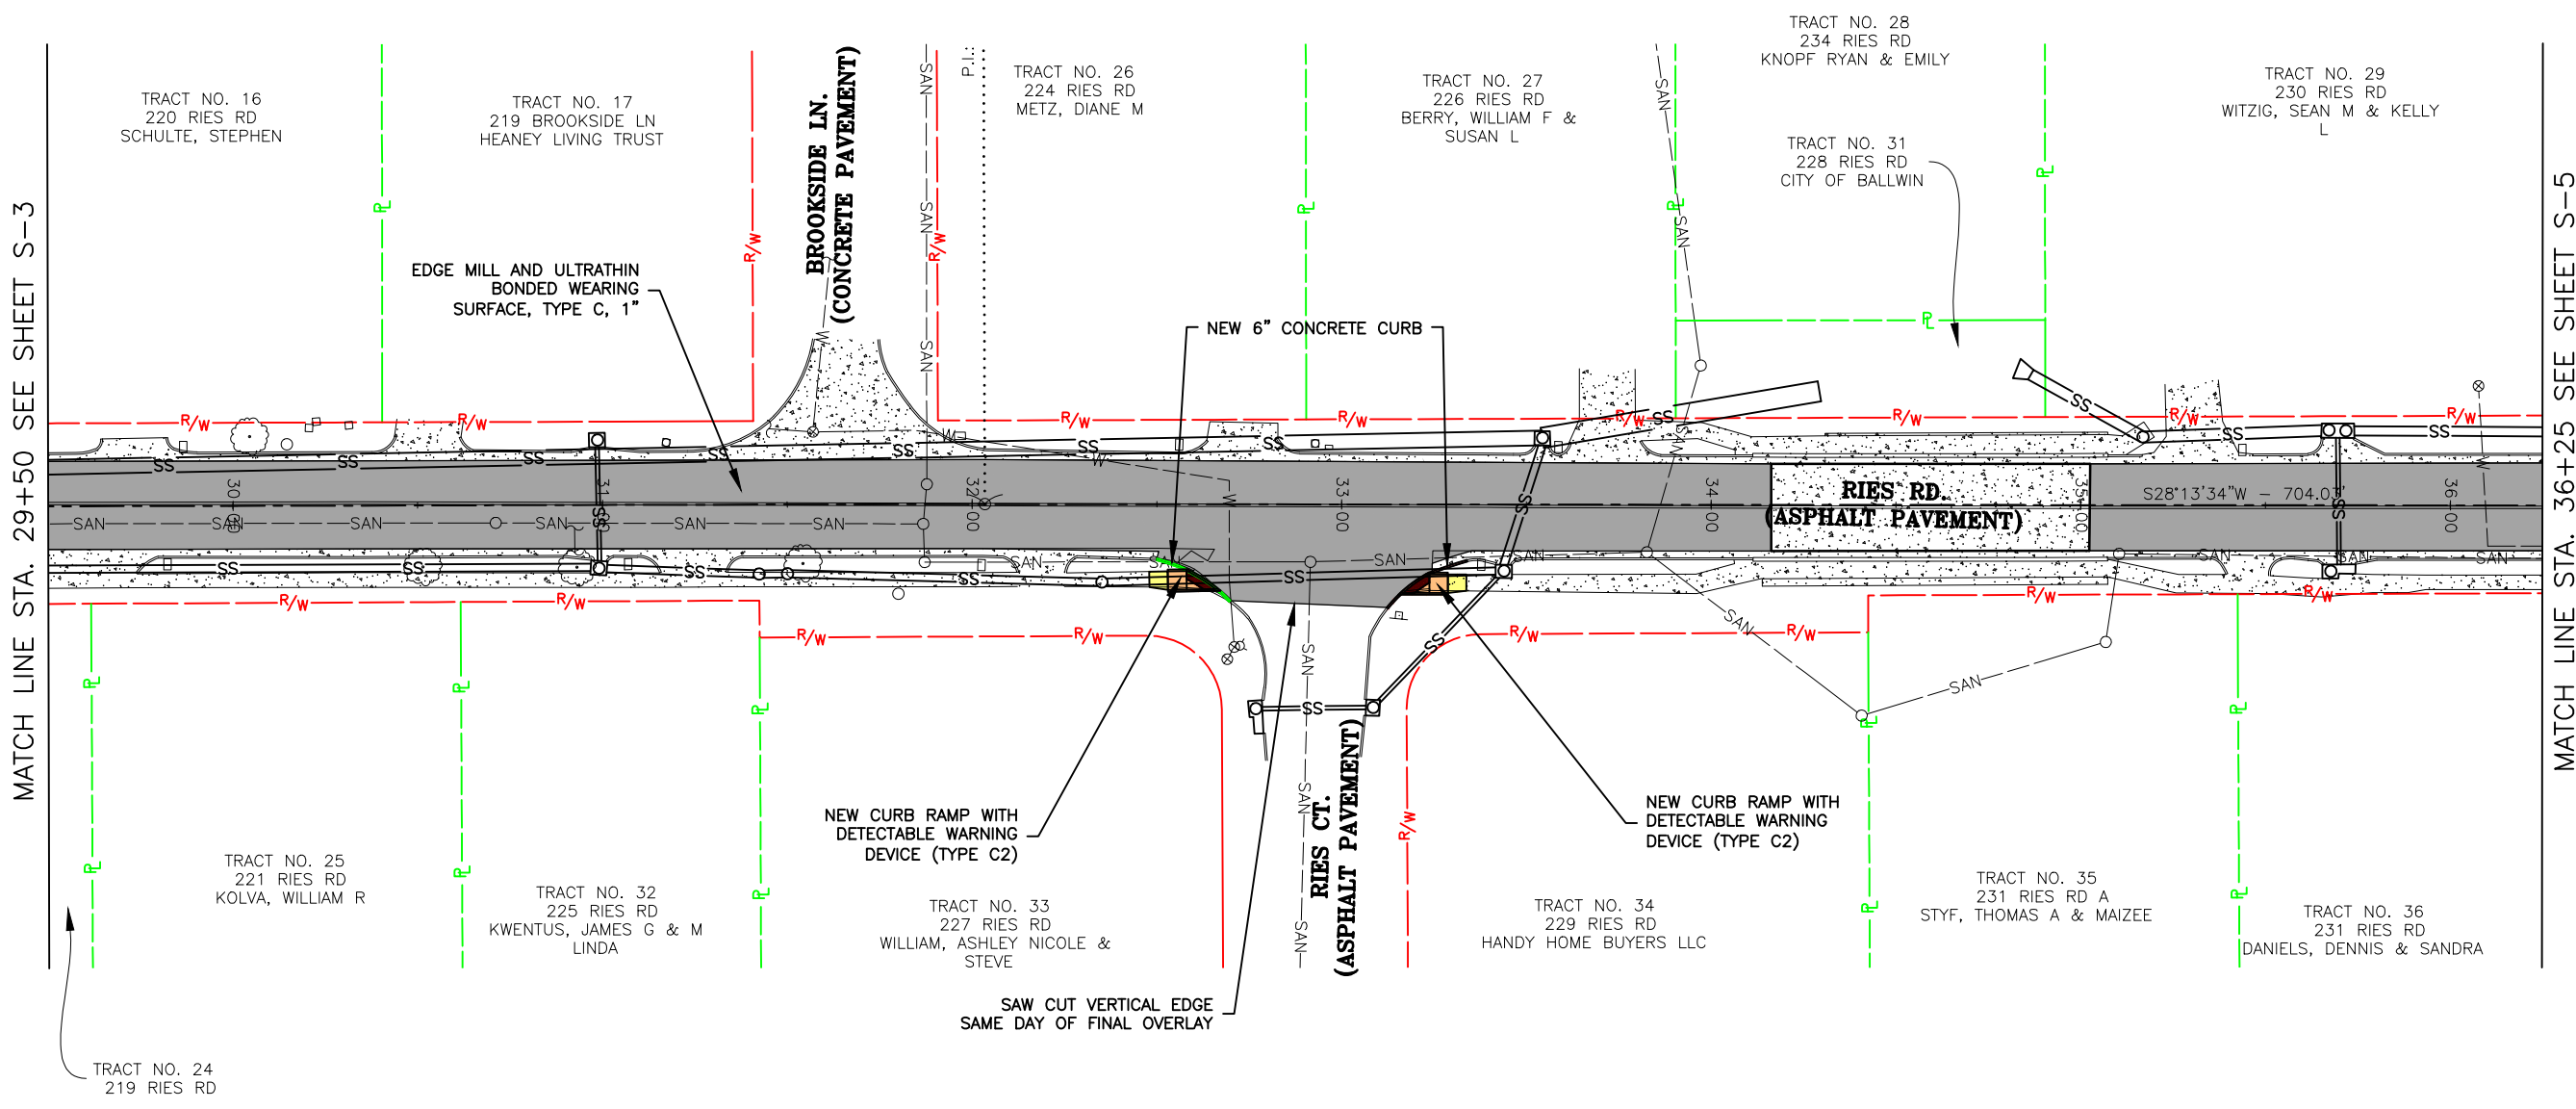
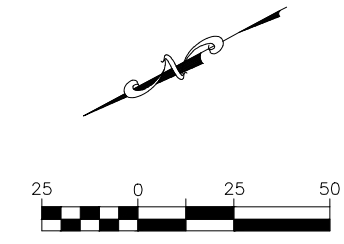
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DWG. NO.:	DWG. NO.:
S-3	

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SITE PLAN



MATCH LINE STA. 29+50 SEE SHEET S-3

MATCH LINE STA. 36+25 SEE SHEET S-5

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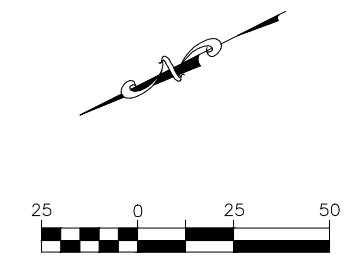
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PROJ. NO.:	PROJ. NO.:
DWG. NO.:	DWG. NO.:
S-4	

SITE PLAN



TRACT NO. 29
230 RIES RD
WITZIG, SEAN M & KELLY
L

TRACT NO. 28
234 RIES RD
KNOPF RYAN & EMILY

TRACT NO. 30
219 BARKER LN
METZGER, JAMES I JR

TRACT NO. 37
238 RIES RD
HELTON, DANIEL J &
RUITING

TRACT NO. 38
242 RIES RD
CHAO, ANDREW Y & DAILING
L

TRACT NO. 36
231 RIES RD
DANIELS, DENNIS & SANDRA

TRACT NO. 40
705 JACKSON ST
LANDHOLT THOMAS J &
MELODY R

TRACT NO. 41
235 RIES RD
GOCKEL, MARTHA


TRACT NO. 42
237 RIES RD
KOHOUT, ANGELA D

TRACT NO. 43
239 RIES RD
THOMSON, TIMOTHY P &
KRISTY A

TRACT NO. 44
241 RIES RD
DUKE HOMES LLC

MATCH LINE STA. 36+25 SEE SHEET S-4

MATCH LINE STA. 43+00 SEE SHEET S-6

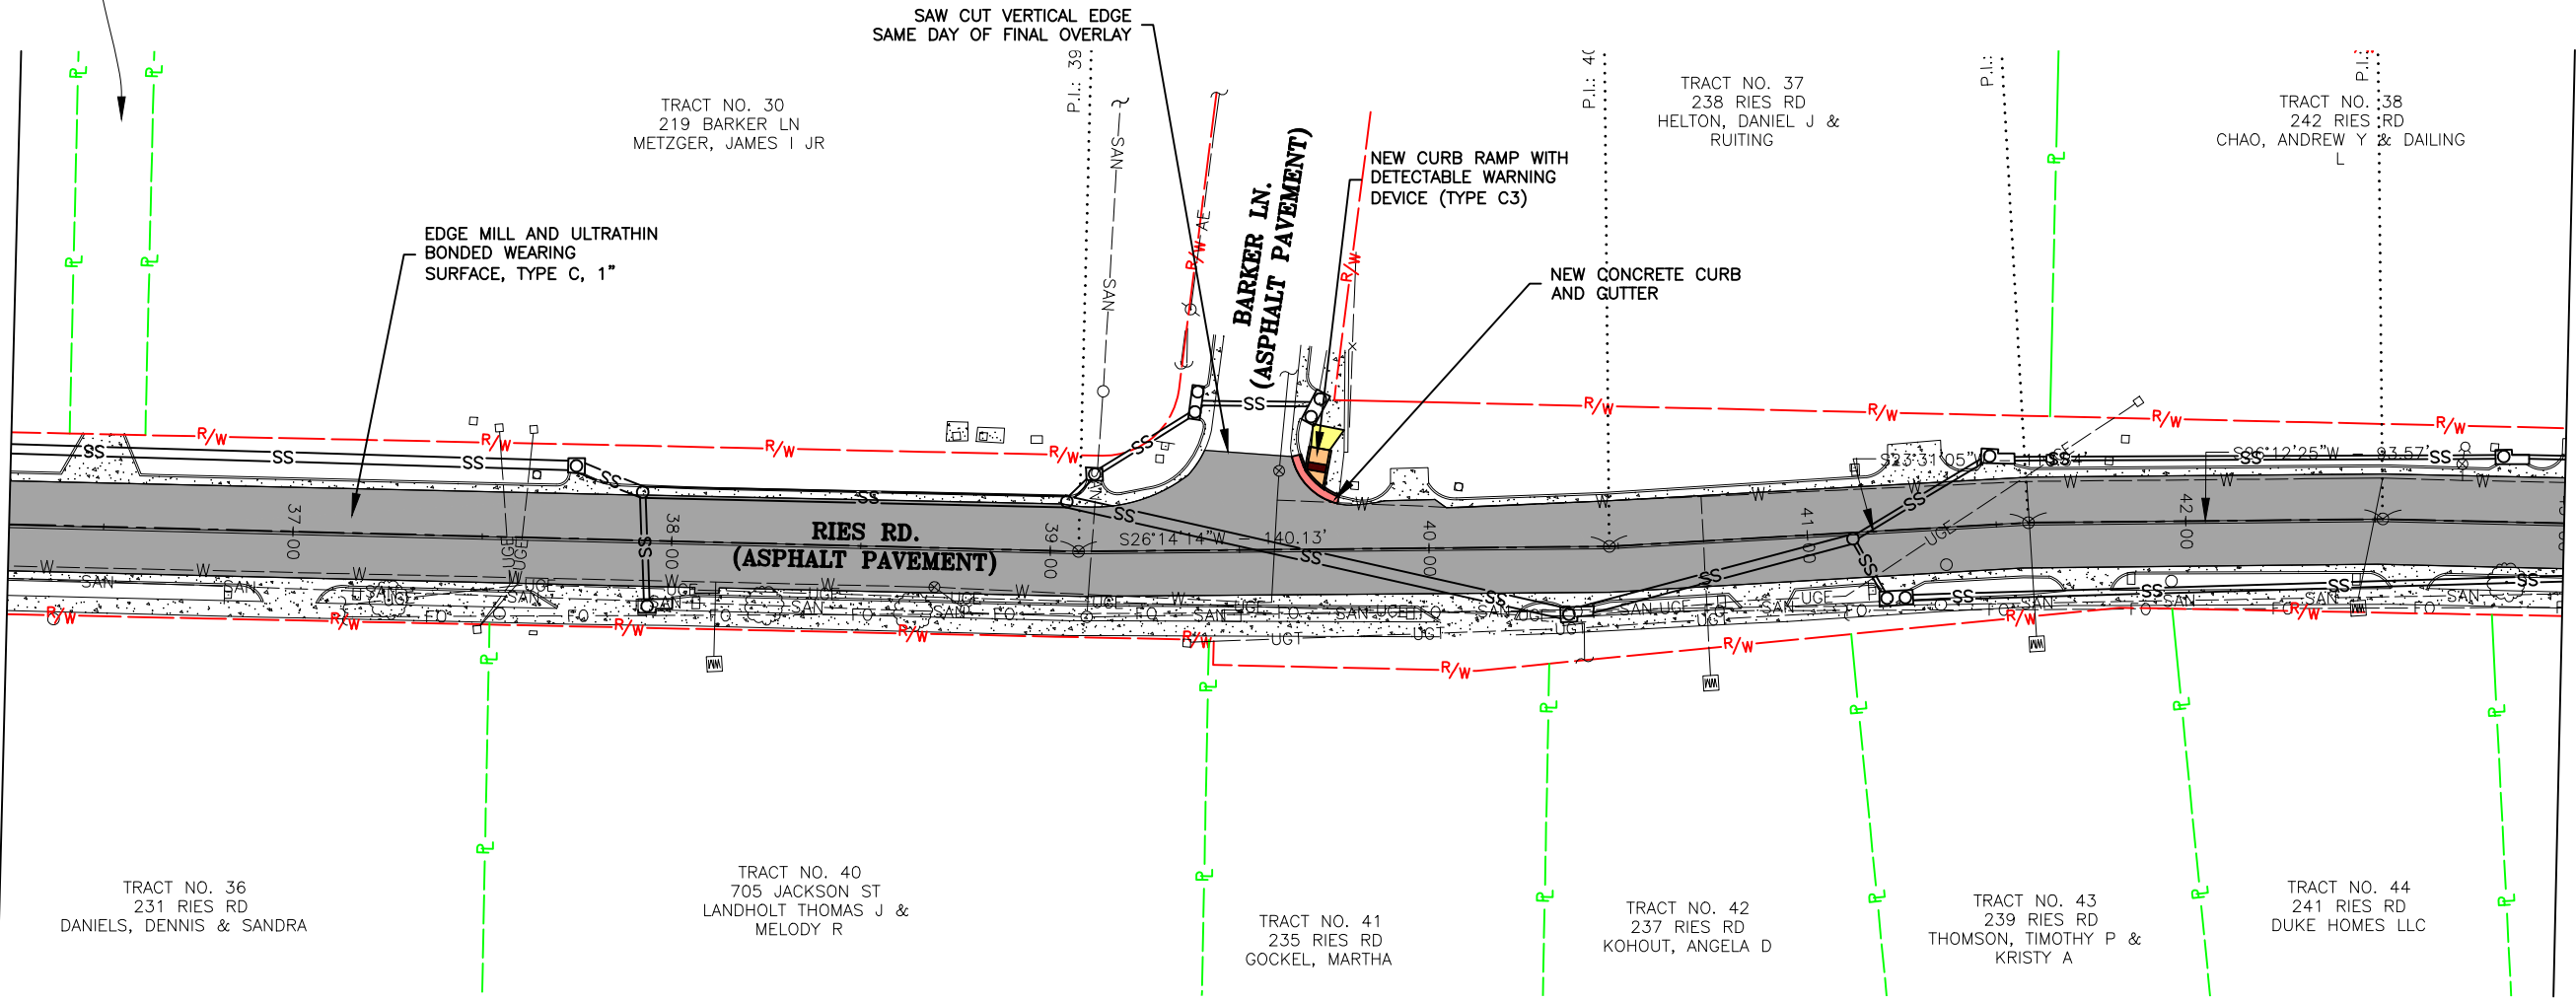

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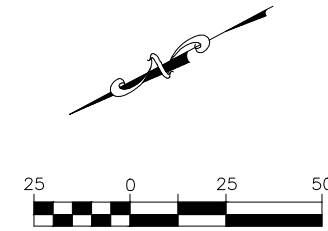
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M.D.M.	K.J.W.
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SCALE:	1" = 50'
PROJ. NO.:	SC19-1061
DWG. NO.:	S-5

SITE PLAN



TRACT NO. 38
242 RIES RD
CHAO, ANDREW Y & DAILING

TRACT NO. 39
246 RIES RD
MACKAY, COLLIN S

TRACT NO. 47
248 RIES RD
CHAUDHRY, ABDUR R &
KOMAL S

TRACT NO. 48
300 RIES BEND RD
NODIFF, STEVEN M

TRACT NO. 49
301 RIES BEND RD
FONTANA, JOSEPH JR &
STEPHANIE

TRACT NO. 50
258 RIES RD
SCHWAMB, WAYNE A &
ROWANA

EDGE MILL AND ULTRATHIN
BONDED WEARING
SURFACE, TYPE C, 1"

SAW CUT VERTICAL EDGE
SAME DAY OF FINAL OVERLAY

NEW CONCRETE CURB
AND GUTTER

NEW CURB RAMP WITH
DETECTABLE WARNING
DEVICE (TYPE J1)

MATCH LINE STA. 43+00 SEE SHEET S-5

MATCH LINE STA. 49+75 SEE SHEET S-7

RIES RD.
(ASPHALT PAVEMENT)

NEW CURB RAMP WITH
DETECTABLE WARNING
DEVICE (TYPE J1)

TRACT NO. 54
249 RIES RD
SALTZMAN, DENNIS D

TRACT NO. 55
284 RAMSEY LN
FERRIS, ELIZABETH

TRACT NO. 56
285 RAMSEY LN
RAU, SUSAN LEE

NEW CURB RAMP WITH
DETECTABLE WARNING
DEVICE (TYPE C2)

TRACT NO. 57
283 RAMSEY LN
DAVIS, MASON

TRACT NO. 44
241 RIES RD
DUKE HOMES LLC

TRACT NO. 46
245 RIES RD
NEWMAN, TAYLOR & TODD

TRACT NO. 53
247 RIES RD
DILLS, KATHY

SAW CUT VERTICAL EDGE
SAME DAY OF FINAL OVERLAY

TRACT NO. 58
281 RAMSEY LN
WILSHER, JON E III

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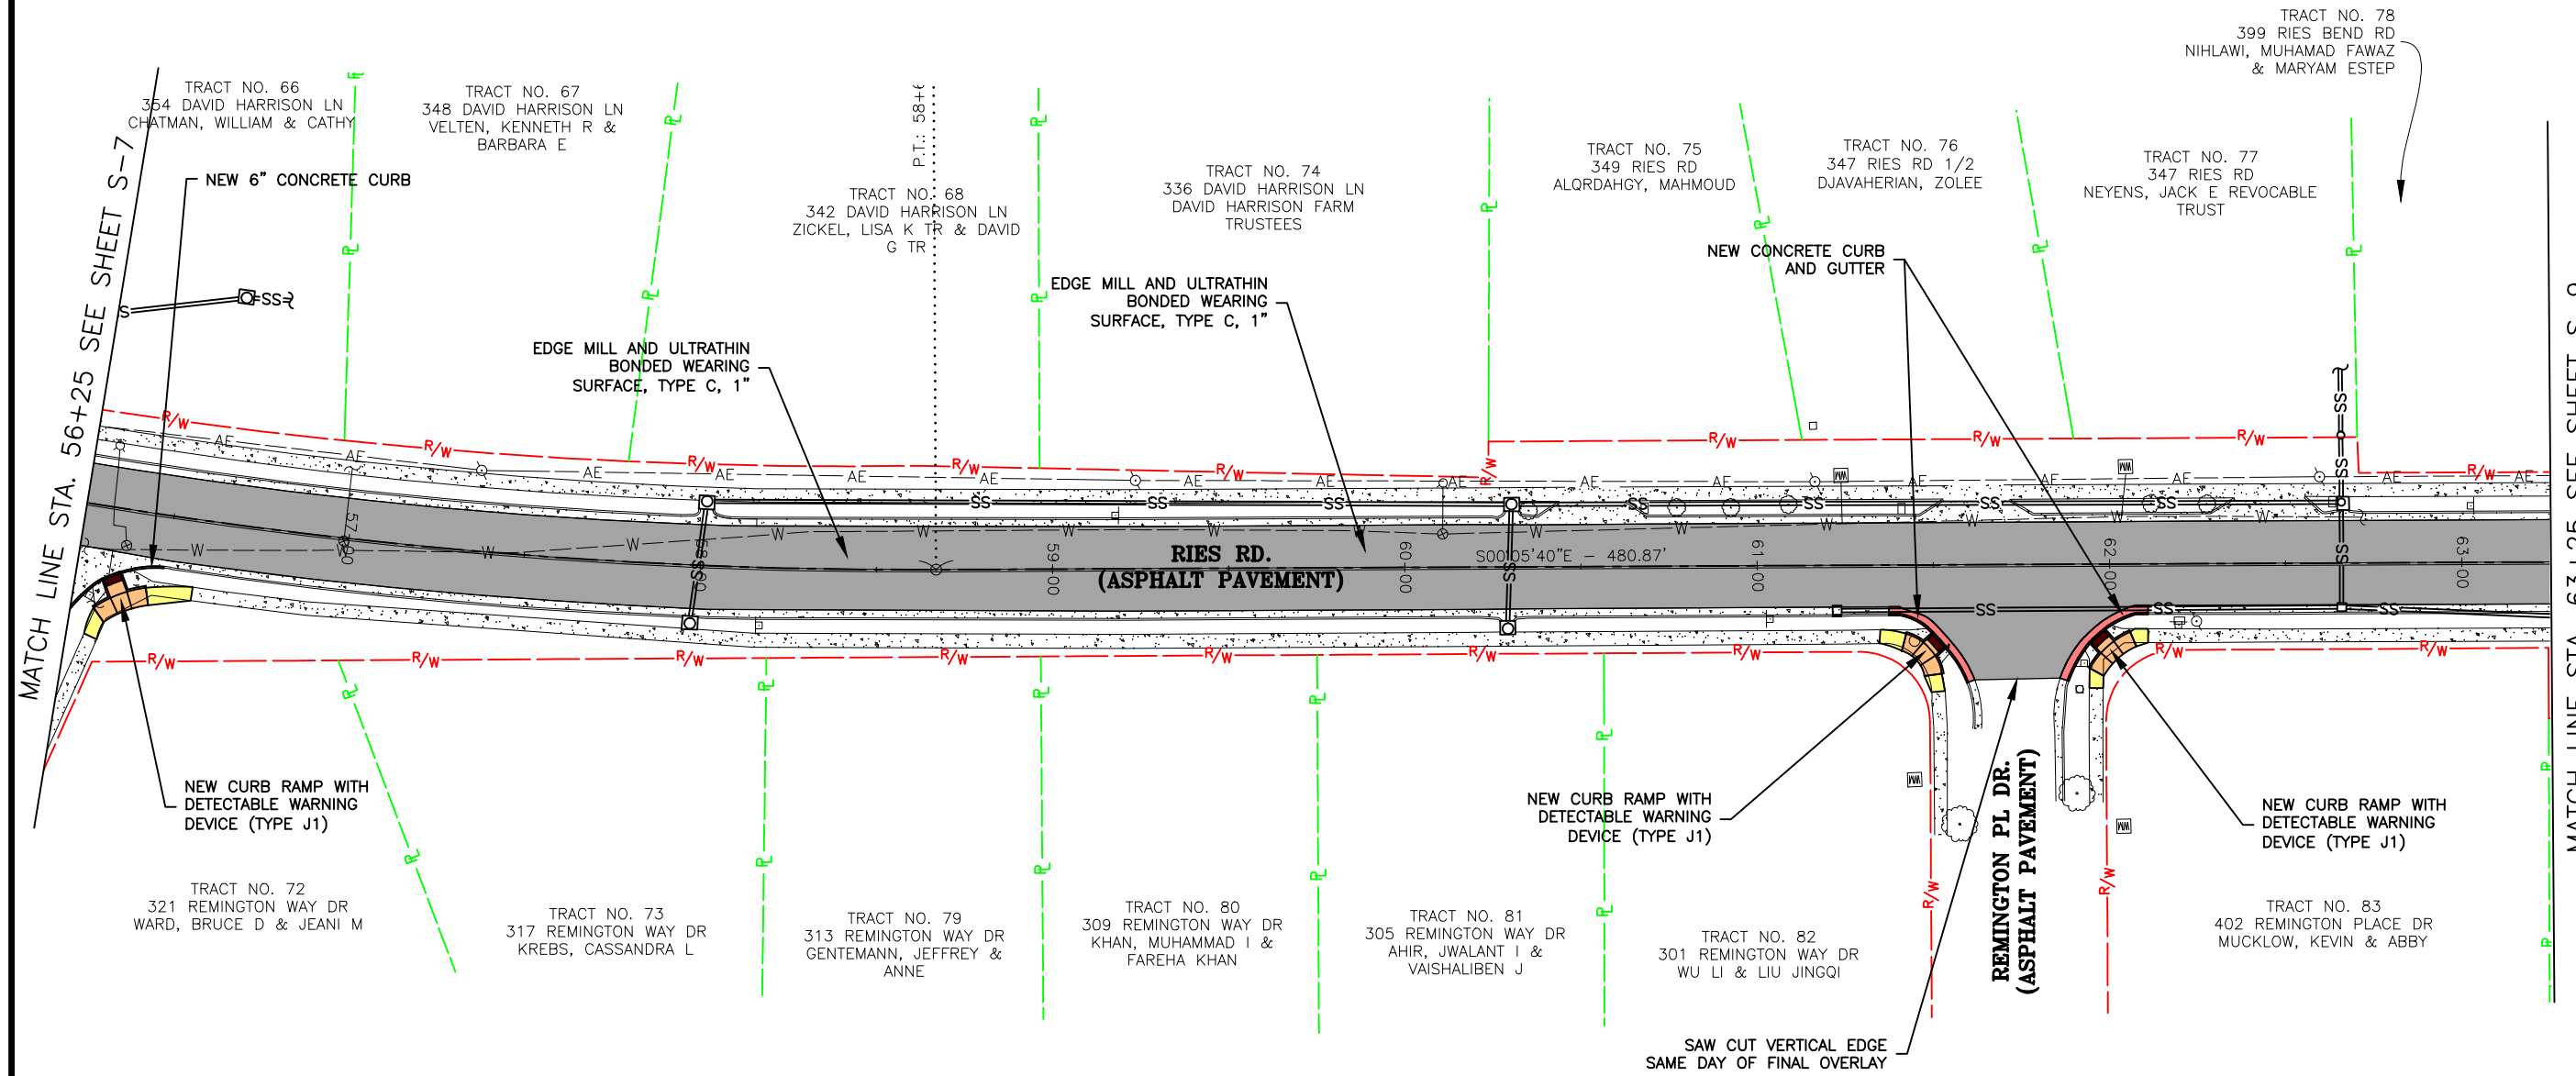
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10/6/23
1" = 50'
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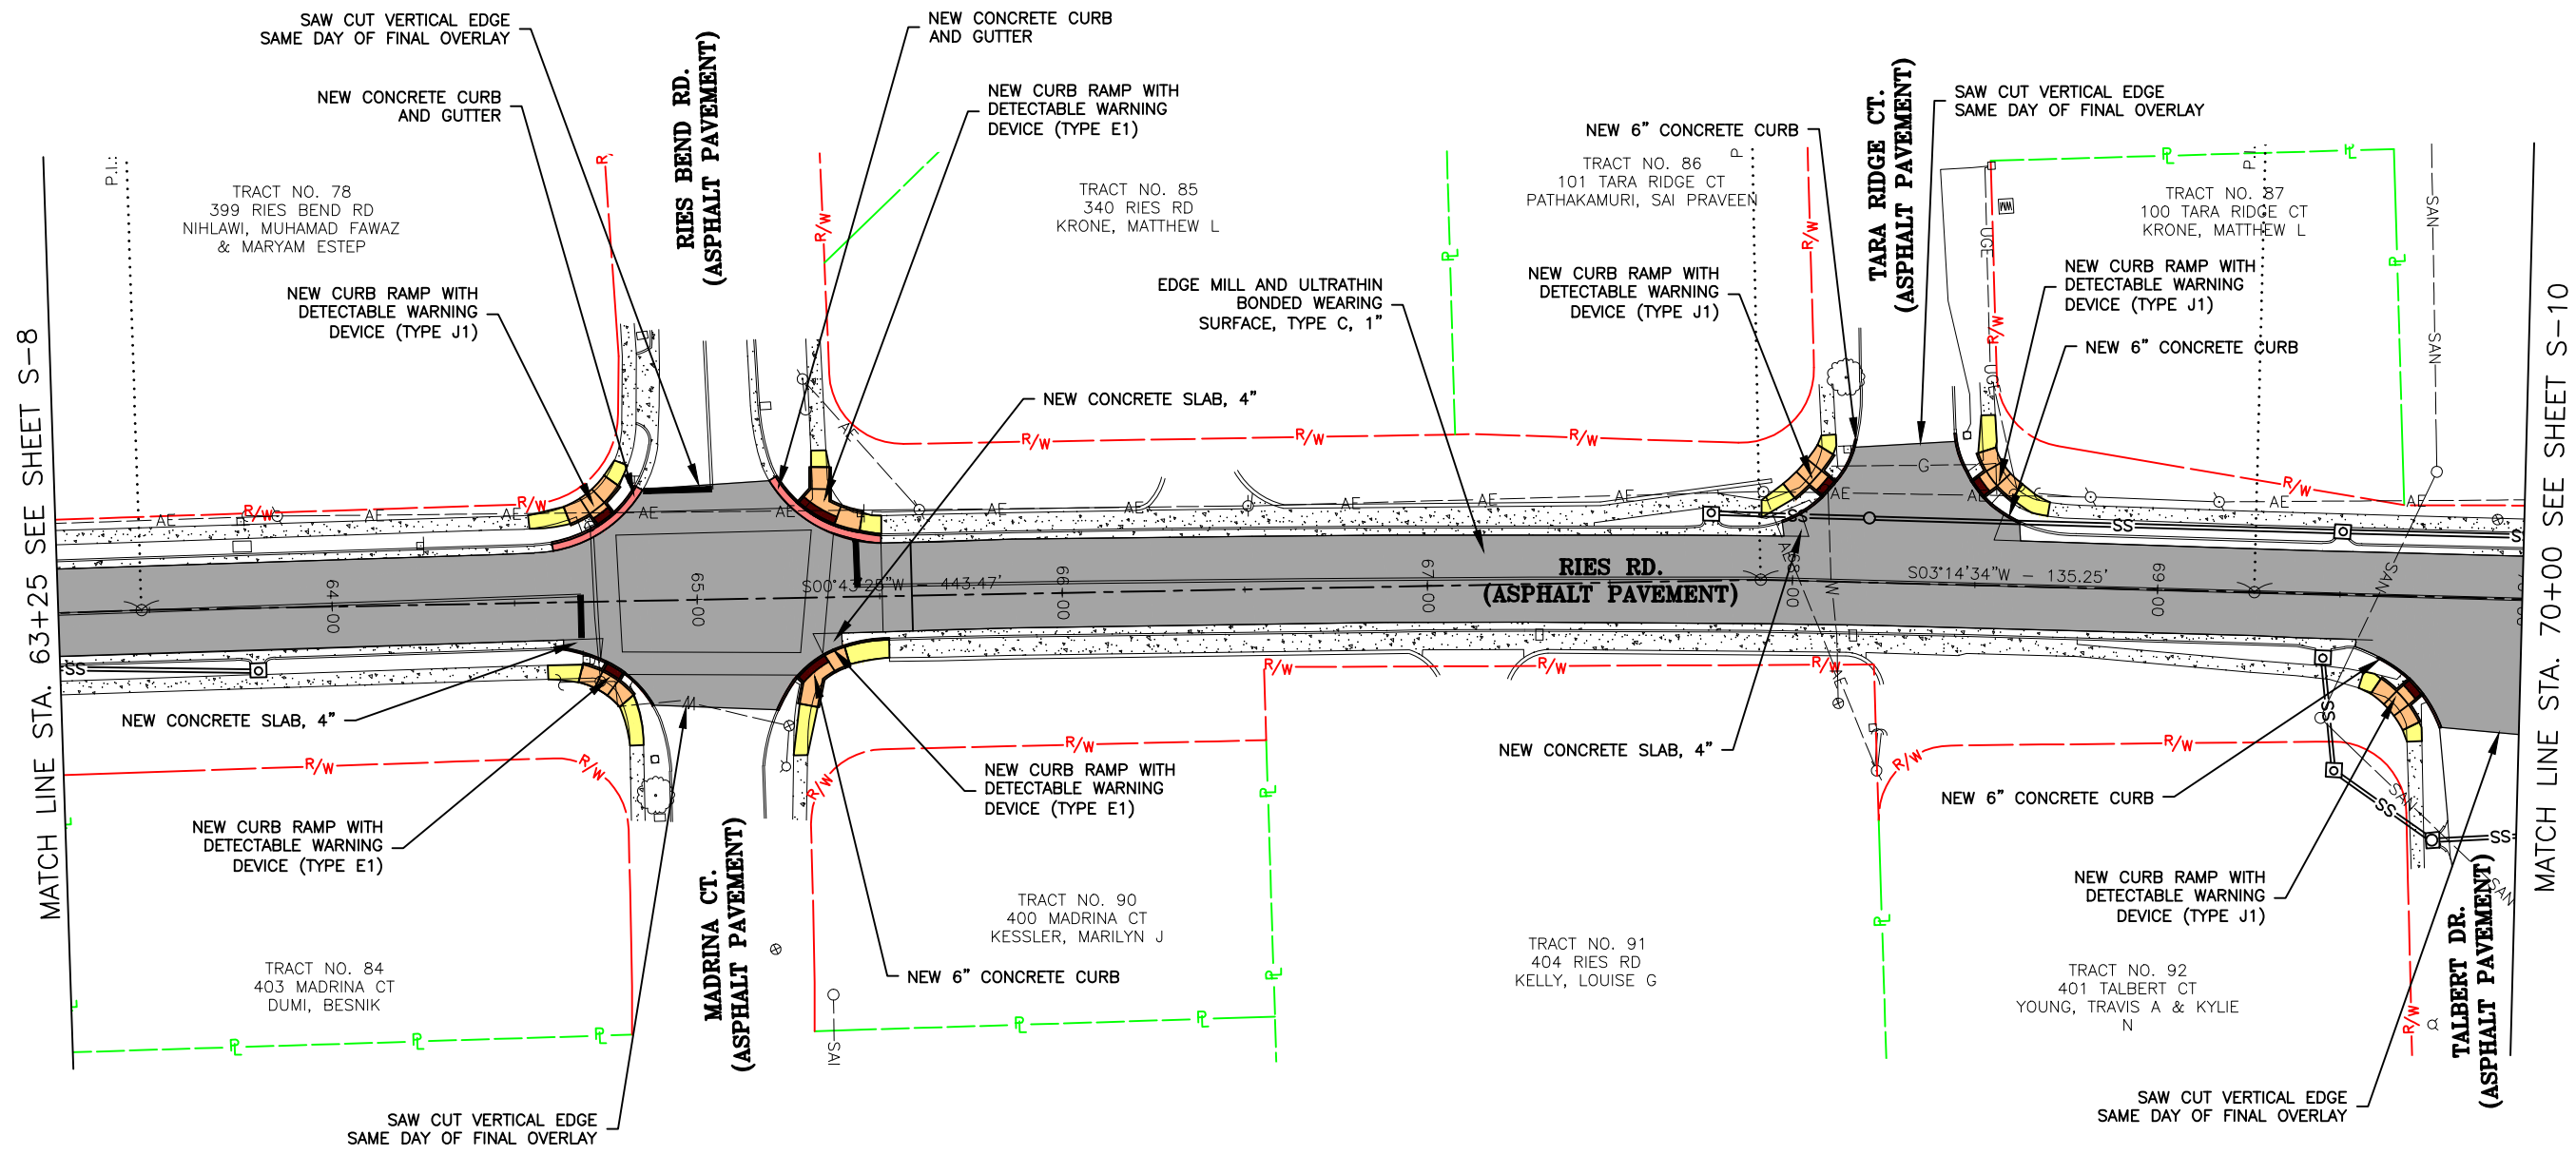
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CITY OF BALLWIN, MISSOURI

SITE PLAN

DATE:	REVISION:
DWN. BY:	APP'D. BY:
DATE:	DATE:
SCALE:	1" = 50'
PROJ. NO:	SC19-1061
DWG. NO:	S-8

Drawing name: U:\SC19-1061 Ballwin Ries Road\AUTOCAD DRAWINGS\SITE PLAN.dwg Tab: S-8 Plotted on: Oct 18, 2023 - 10:36am Plotted by: MSPalding

SITE PLAN



MATCH LINE STA. 63+25 SEE SHEET S-8

MATCH LINE STA. 70+00 SEE SHEET S-10

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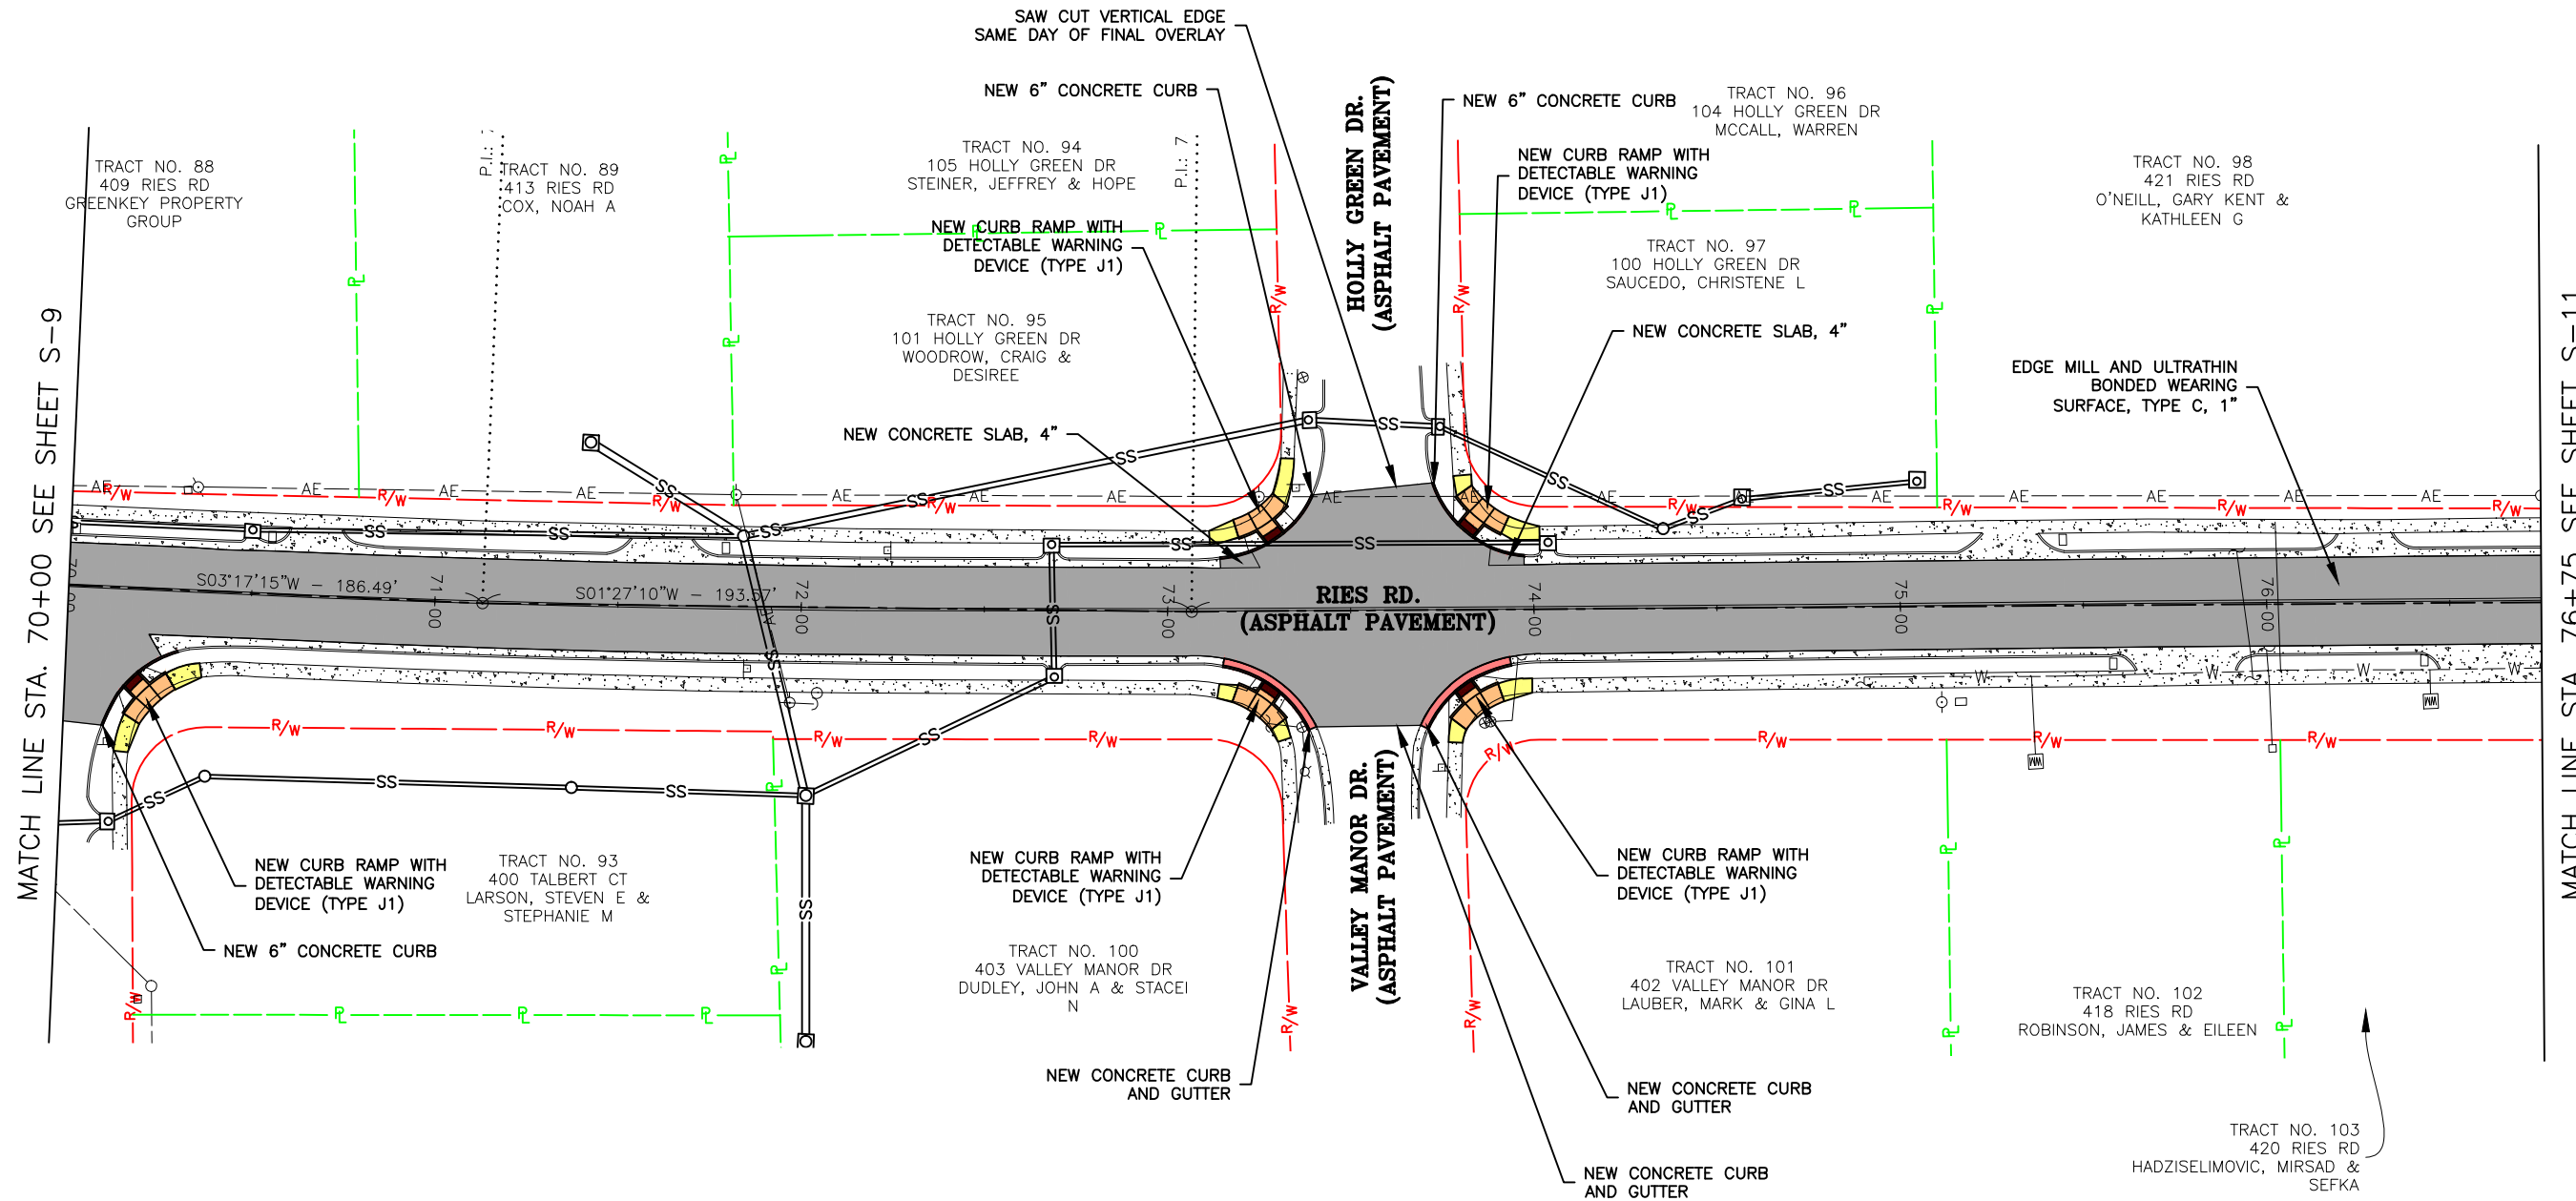
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PROJ. NO.:	PROJ. NO.:
DWG. NO.:	DWG. NO.:
S-9	

SITE PLAN



MATCH LINE STA. 70+00 SEE SHEET S-9

MATCH LINE STA. 76+75 SEE SHEET S-11

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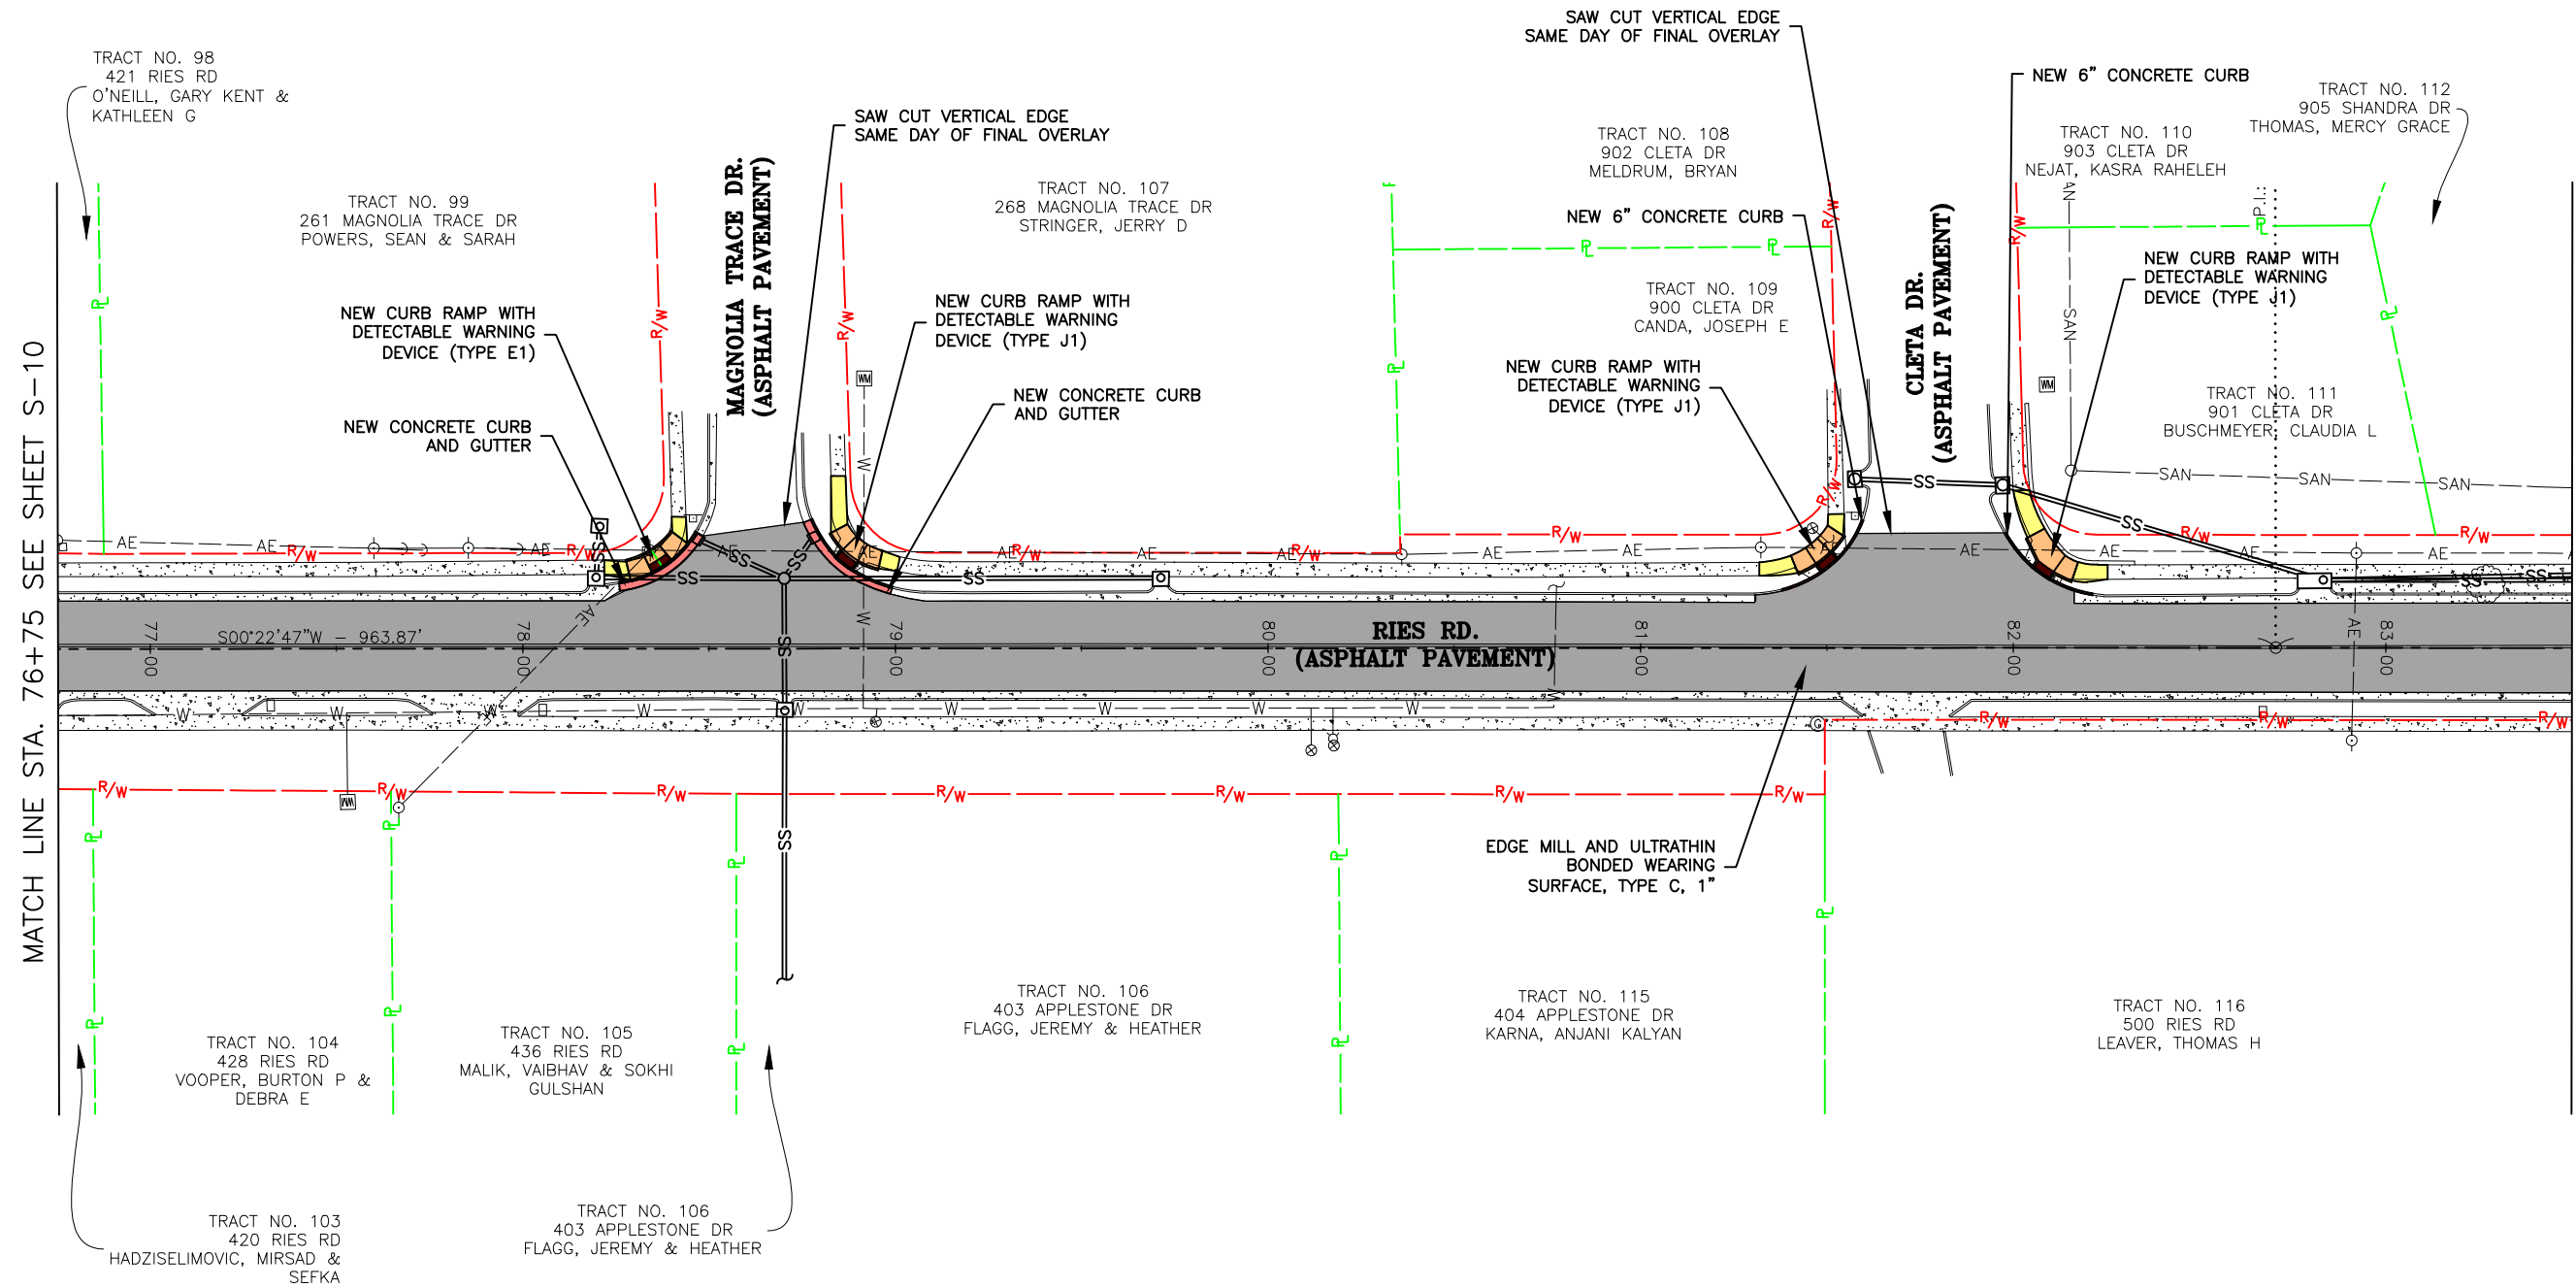
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DWG. NO.:	S-10

SITE PLAN



MATCH LINE STA. 76+75 SEE SHEET S-10

MATCH LINE STA. 83+50 SEE SHEET S-12

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LAND SURVEYING REGISTRATION NO. 2007004529

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TRACT NO. 97
100 HOLLY GREEN DR
SAU


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10/6/23	
SCALE:	
1" = 50'	
PROJ. NO.:	
SC19-1061	
DWG. NO.:	
S-11	

SITE PLAN



MATCH LINE STA. 83+50 SEE SHEET S-11

MATCH LINE STA. 90+00 SEE SHEET S-13
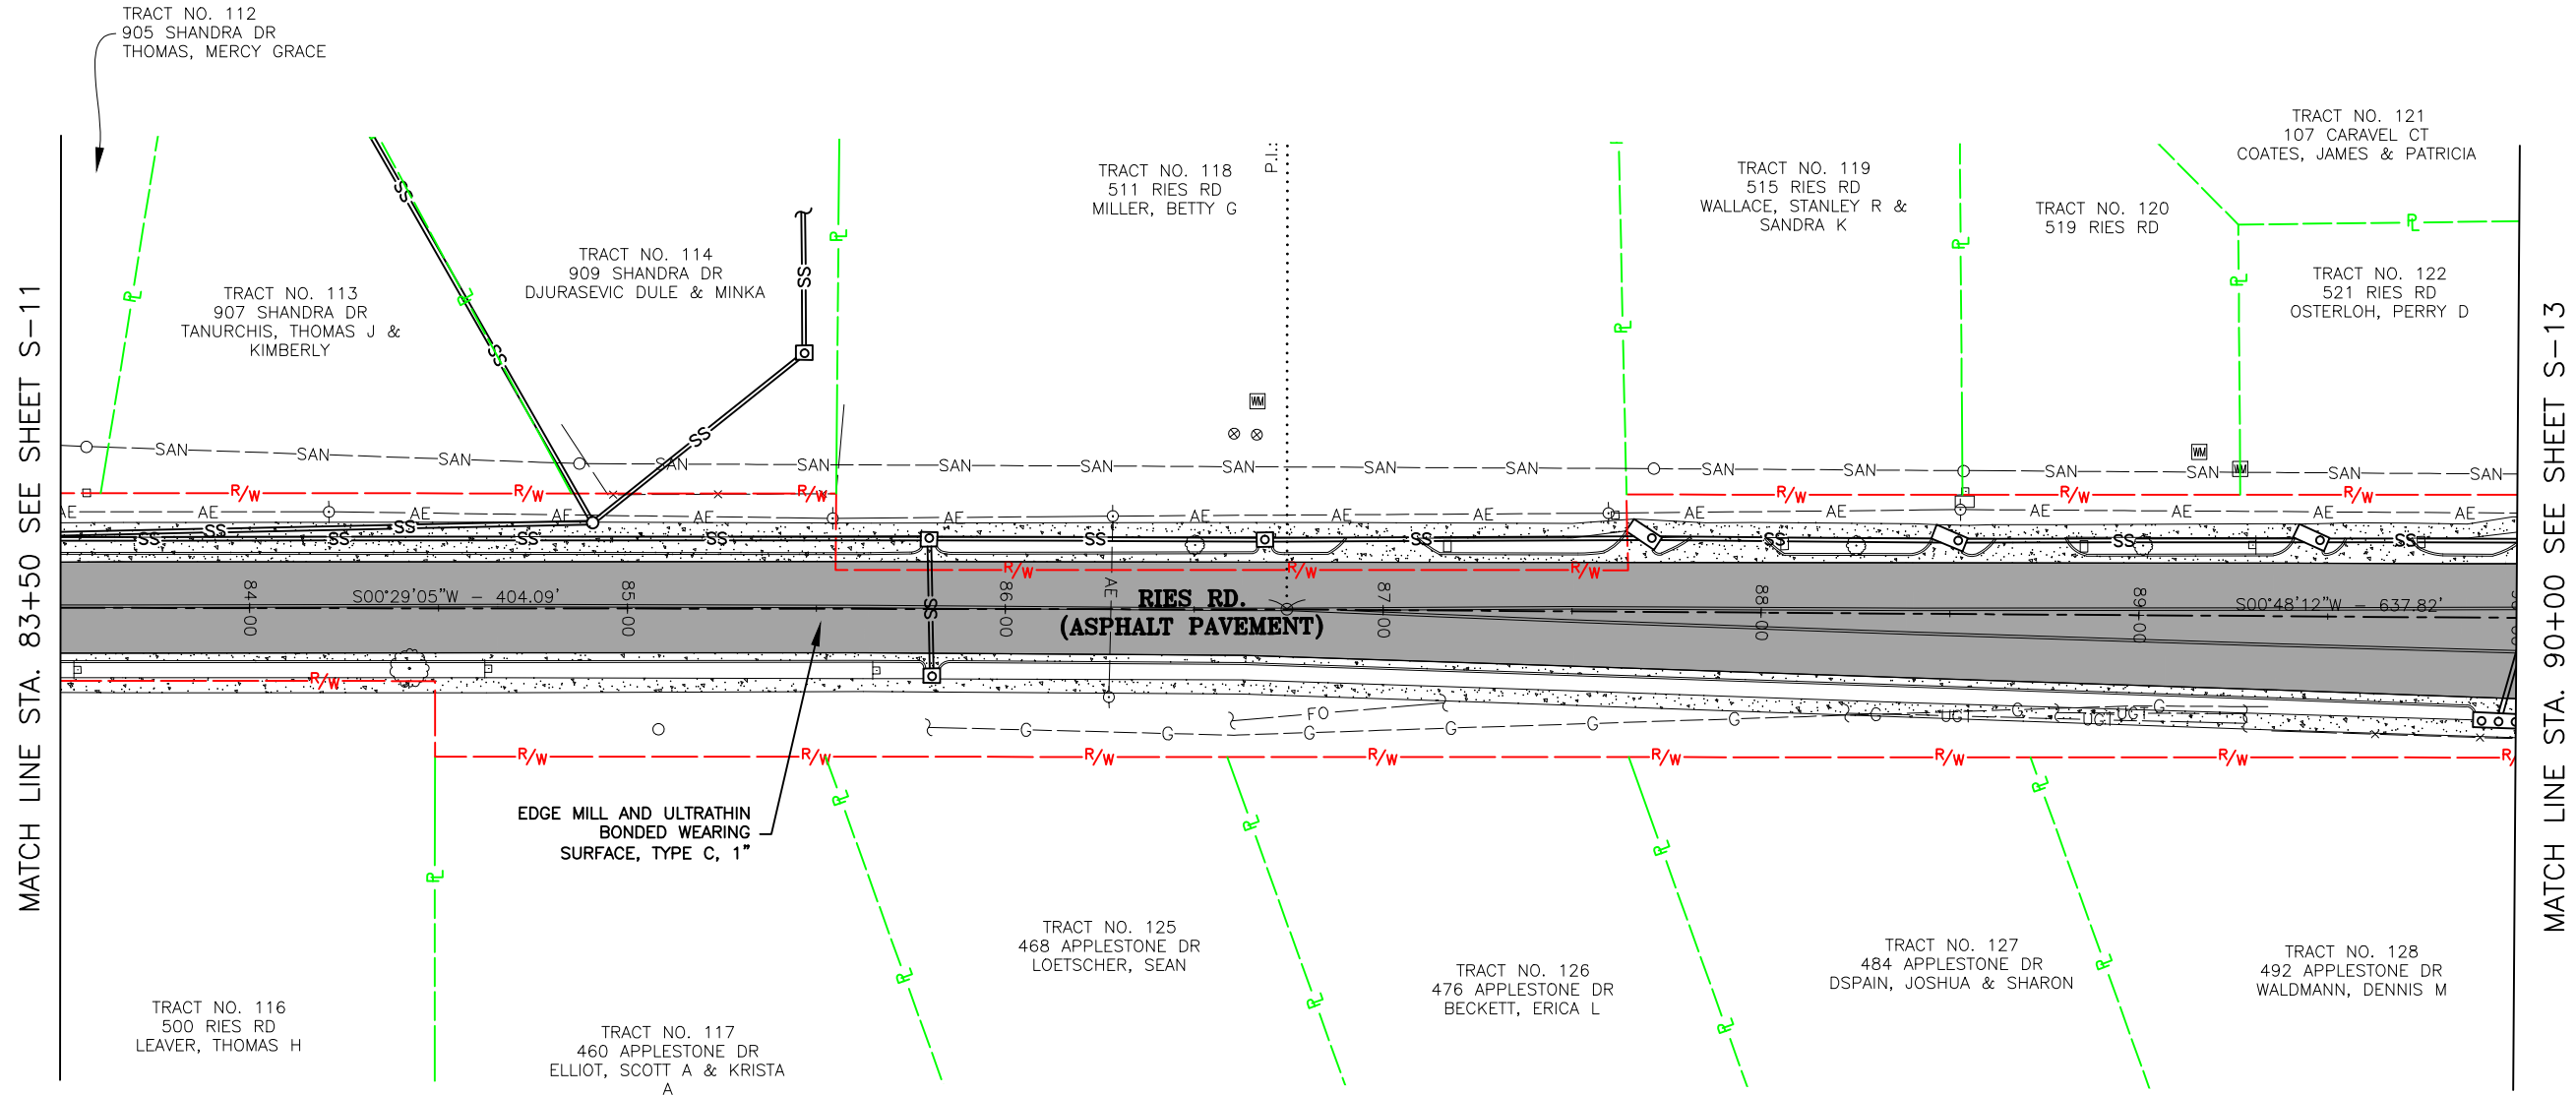
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LAND SURVEYING CERTIFICATE OF AUTHORITY NUMBER - 2007004529



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RIES ROAD IMPROVEMENTS
FEDERAL PROJECT NO. STP-4939(610)
CITY OF BALLWIN, MISSOURI

SITE PLAN	S-12
DATE:	10/6/23
DWN. BY:	M.D.M.
APPD. BY:	K.J.W.
SCALE:	1" = 50'
PROJ. NO.:	SC19-1061
DWG. NO.:	

SITE PLAN



MATCH LINE STA. 90+00 SEE SHEET S-12

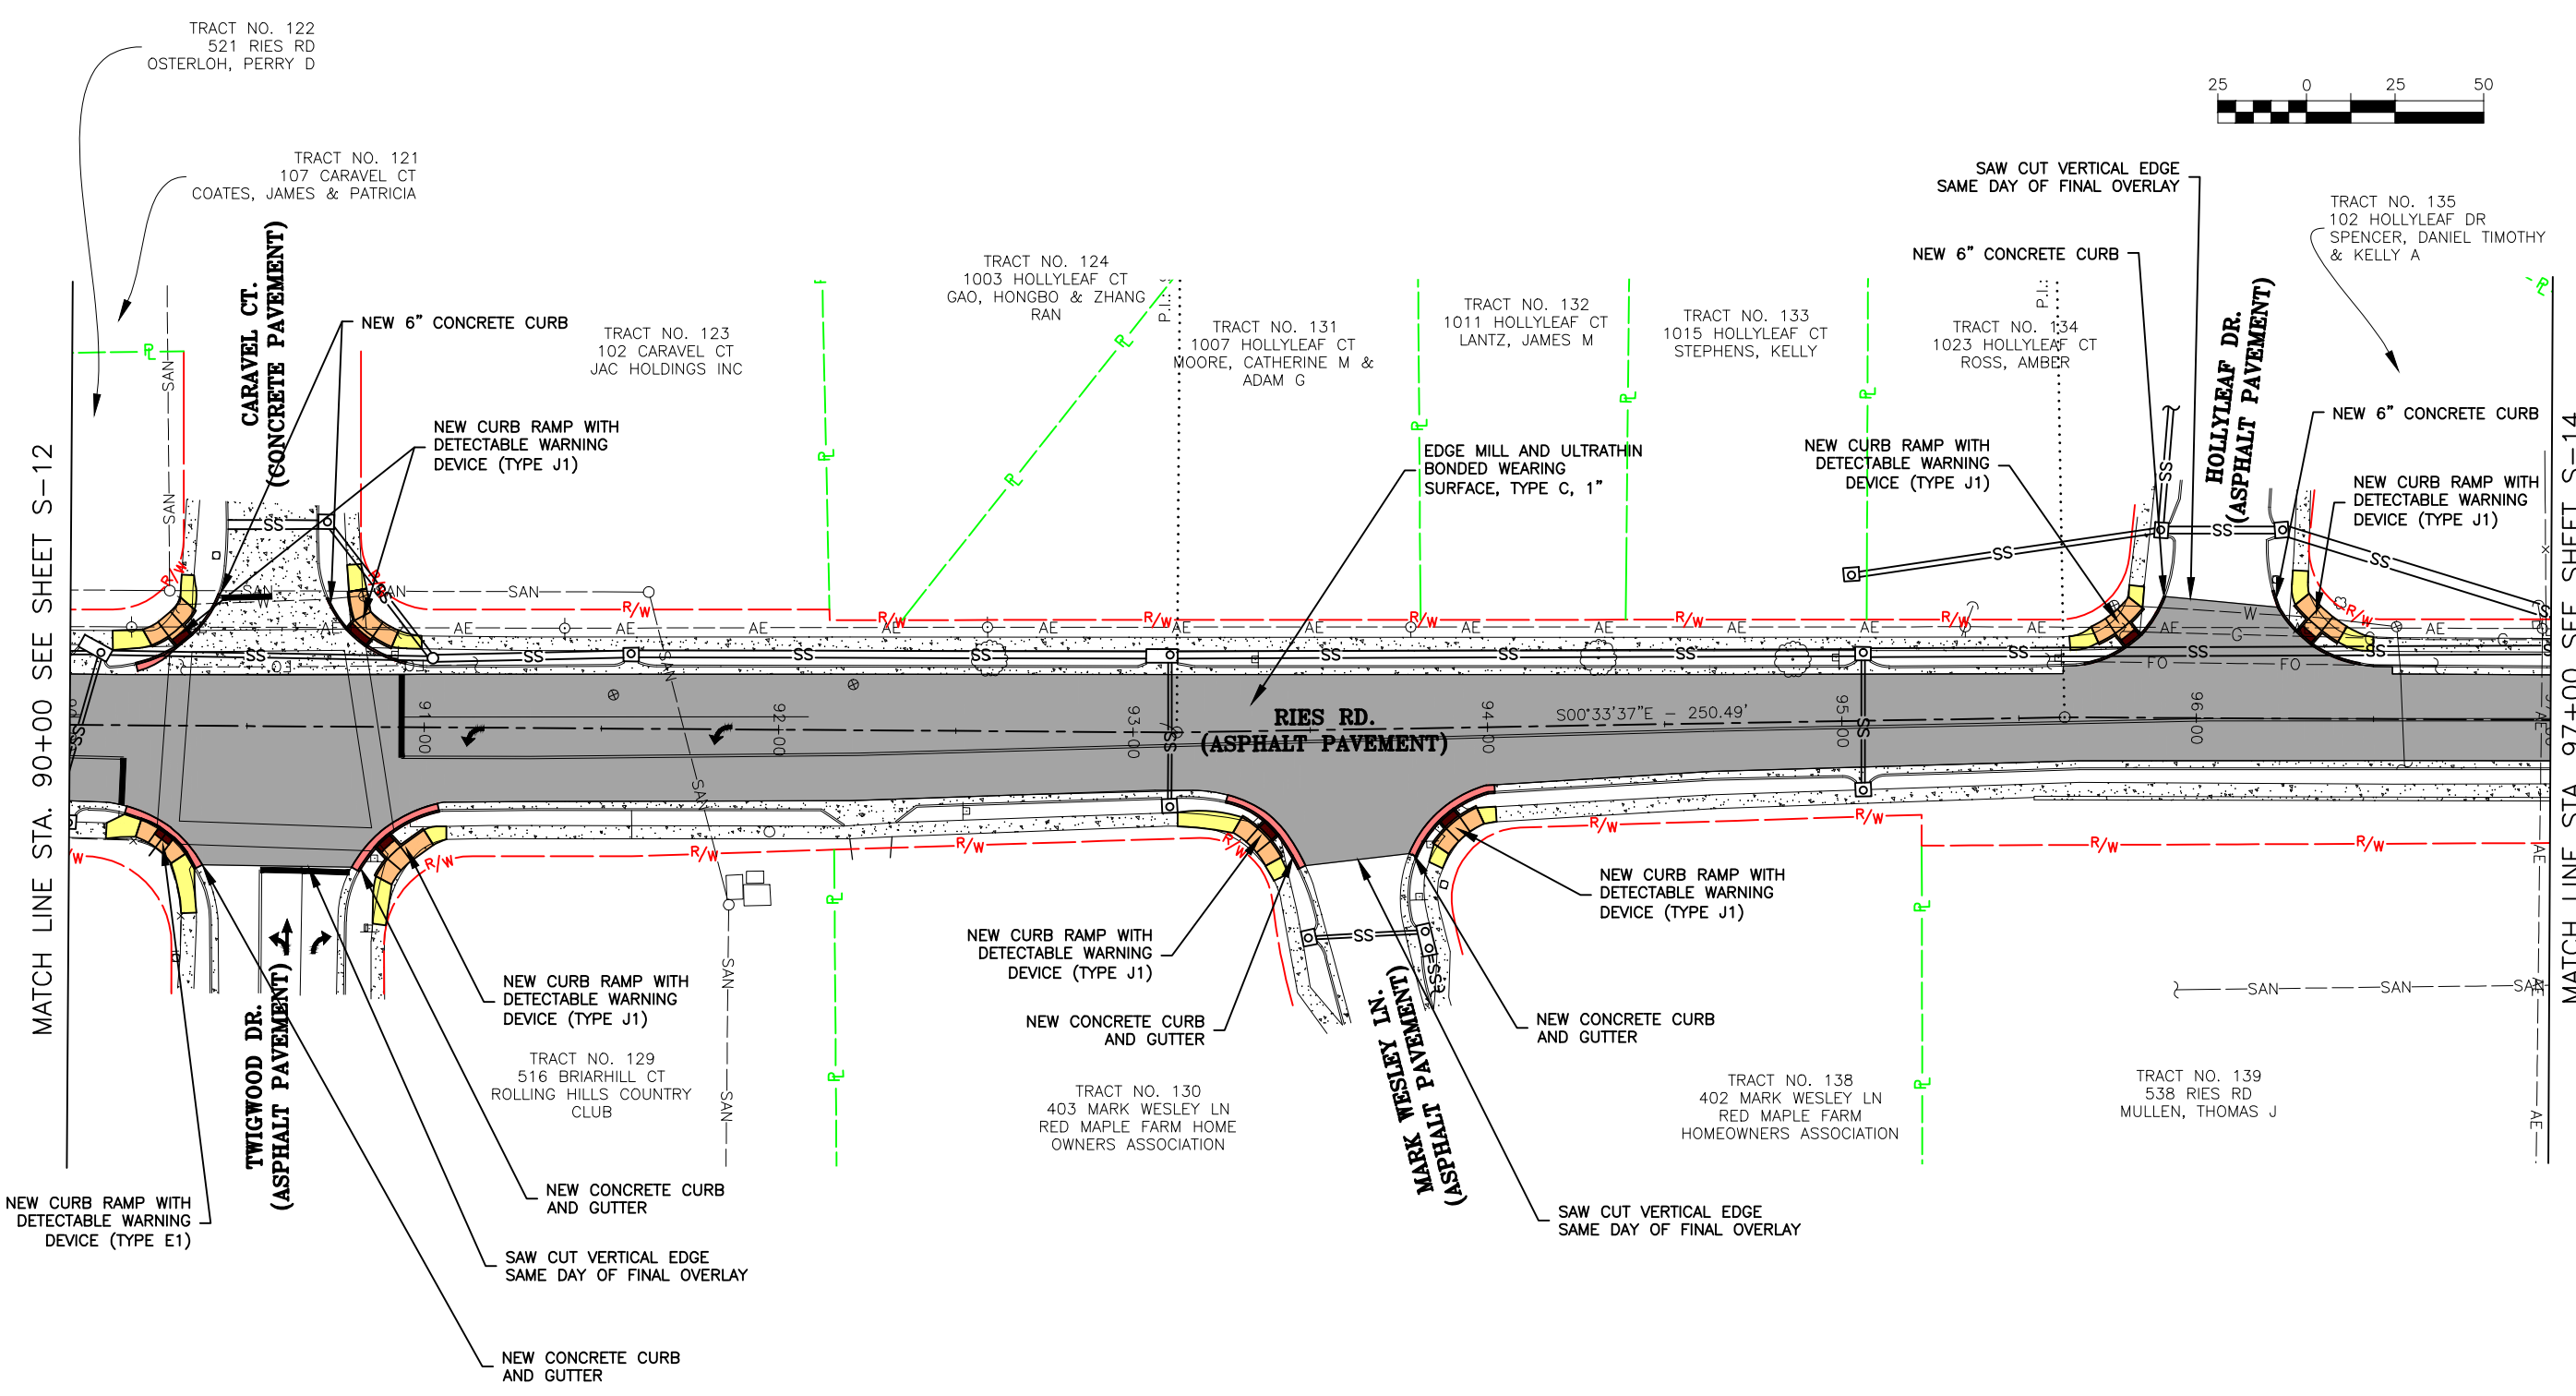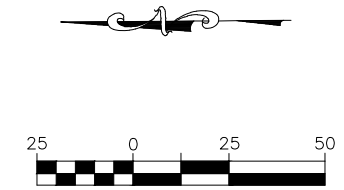MATCH LINE STA. 97+00 SEE SHEET S-14

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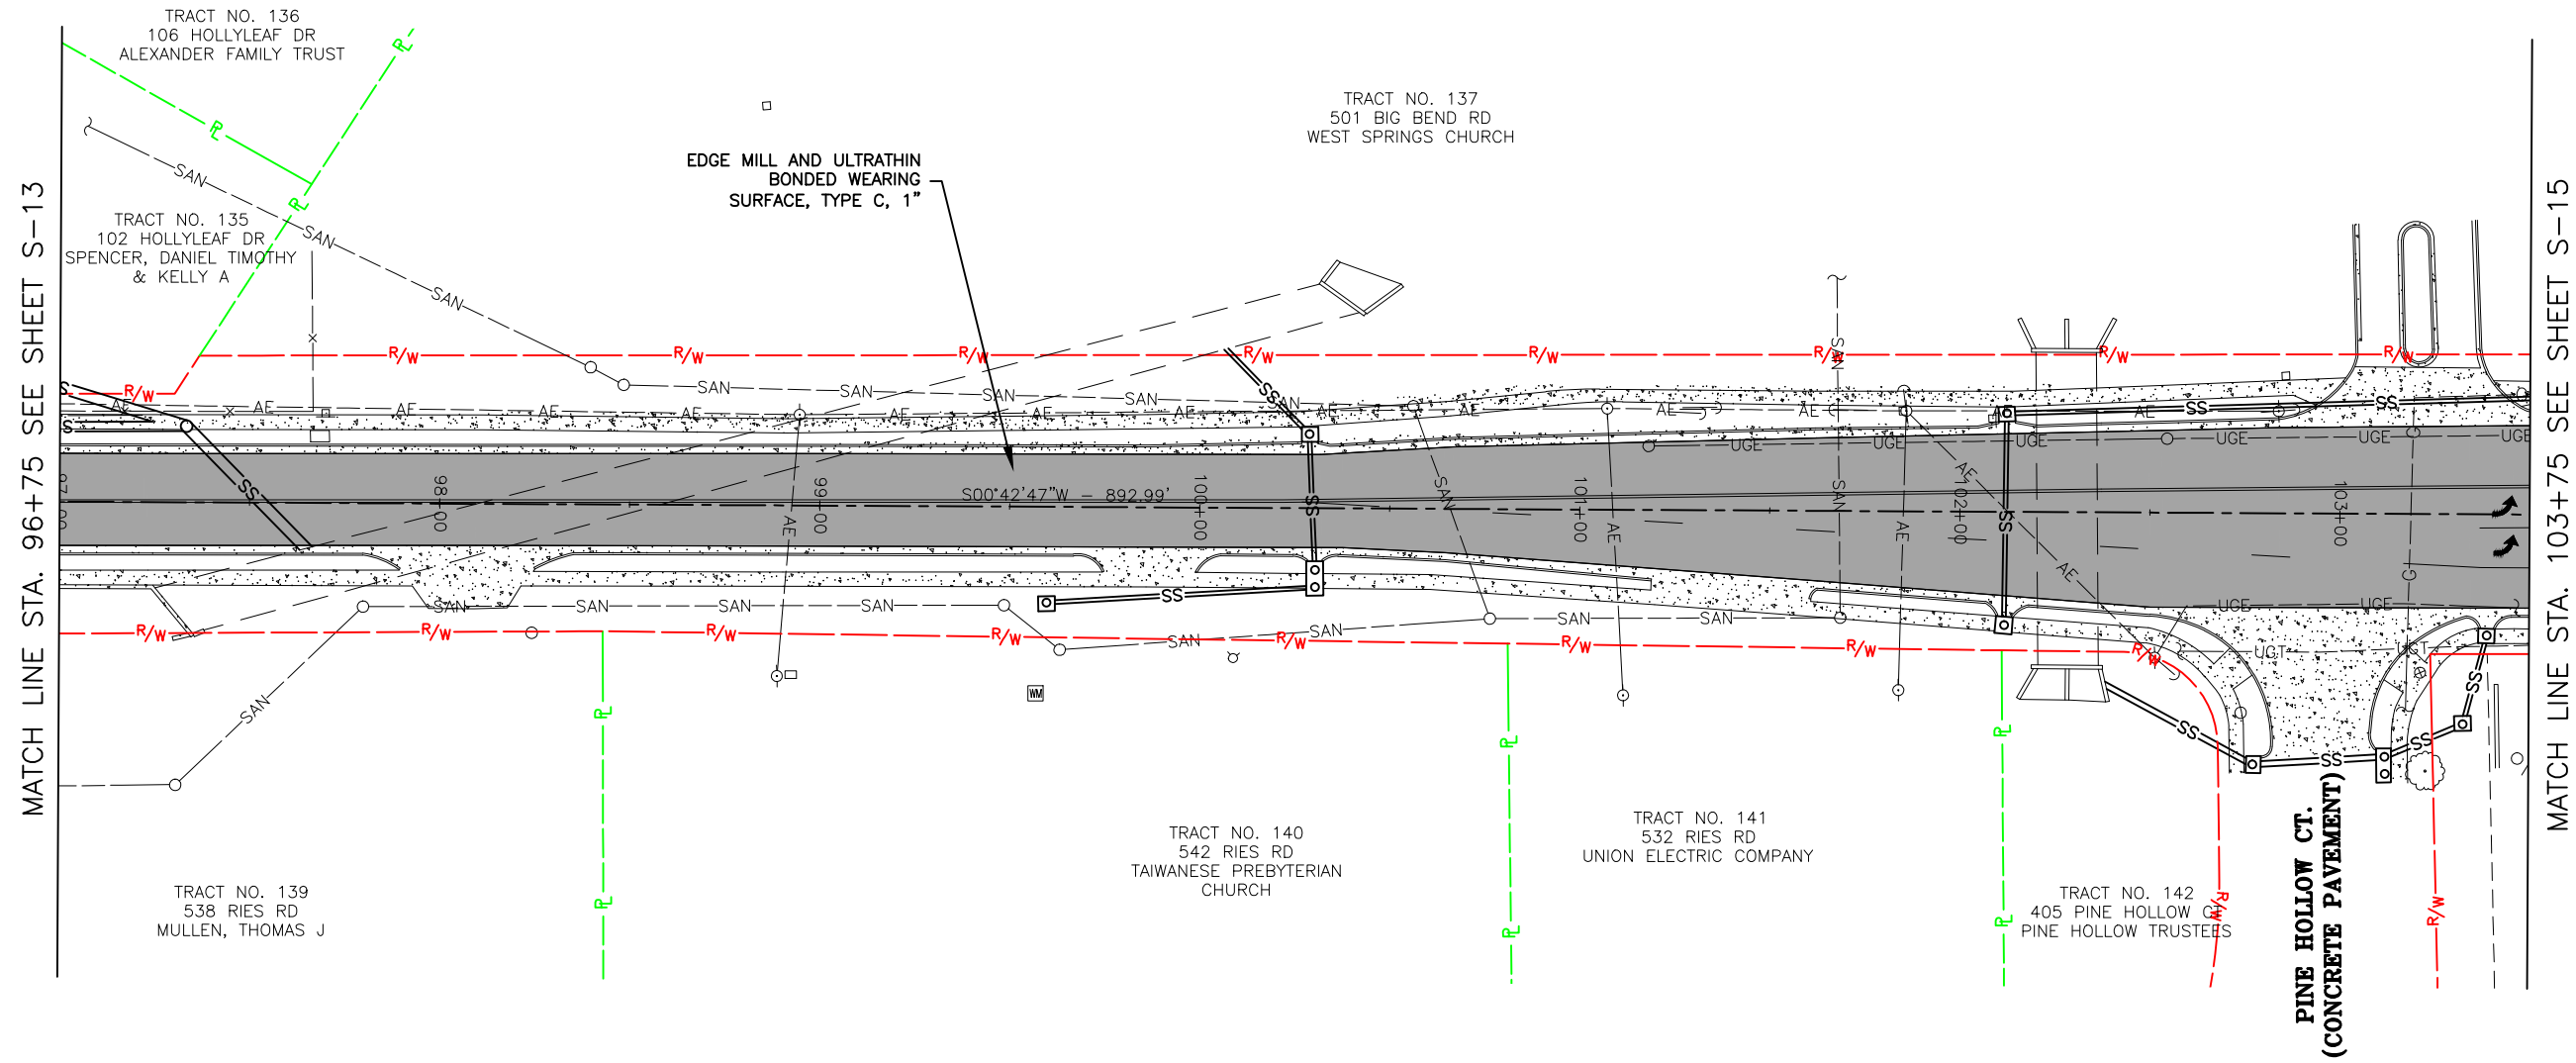
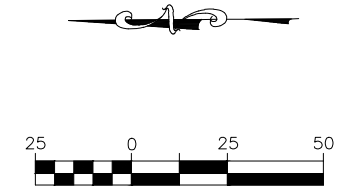
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RIES ROAD IMPROVEMENTS
FEDERAL PROJECT NO. STP-4939(610)
CITY OF BALLWIN, MISSOURI

DATE:	REVISION:
DWN. BY:	APP'D. BY:
M.D.M.	K.J.W.
DATE:	10/6/23
SCALE:	1" = 50'
PROJ. NO.:	SC19-1061
DWG. NO.:	S-13

SITE PLAN



MATCH LINE STA. 96+75 SEE SHEET S-13

MATCH LINE STA. 103+75 SEE SHEET S-15

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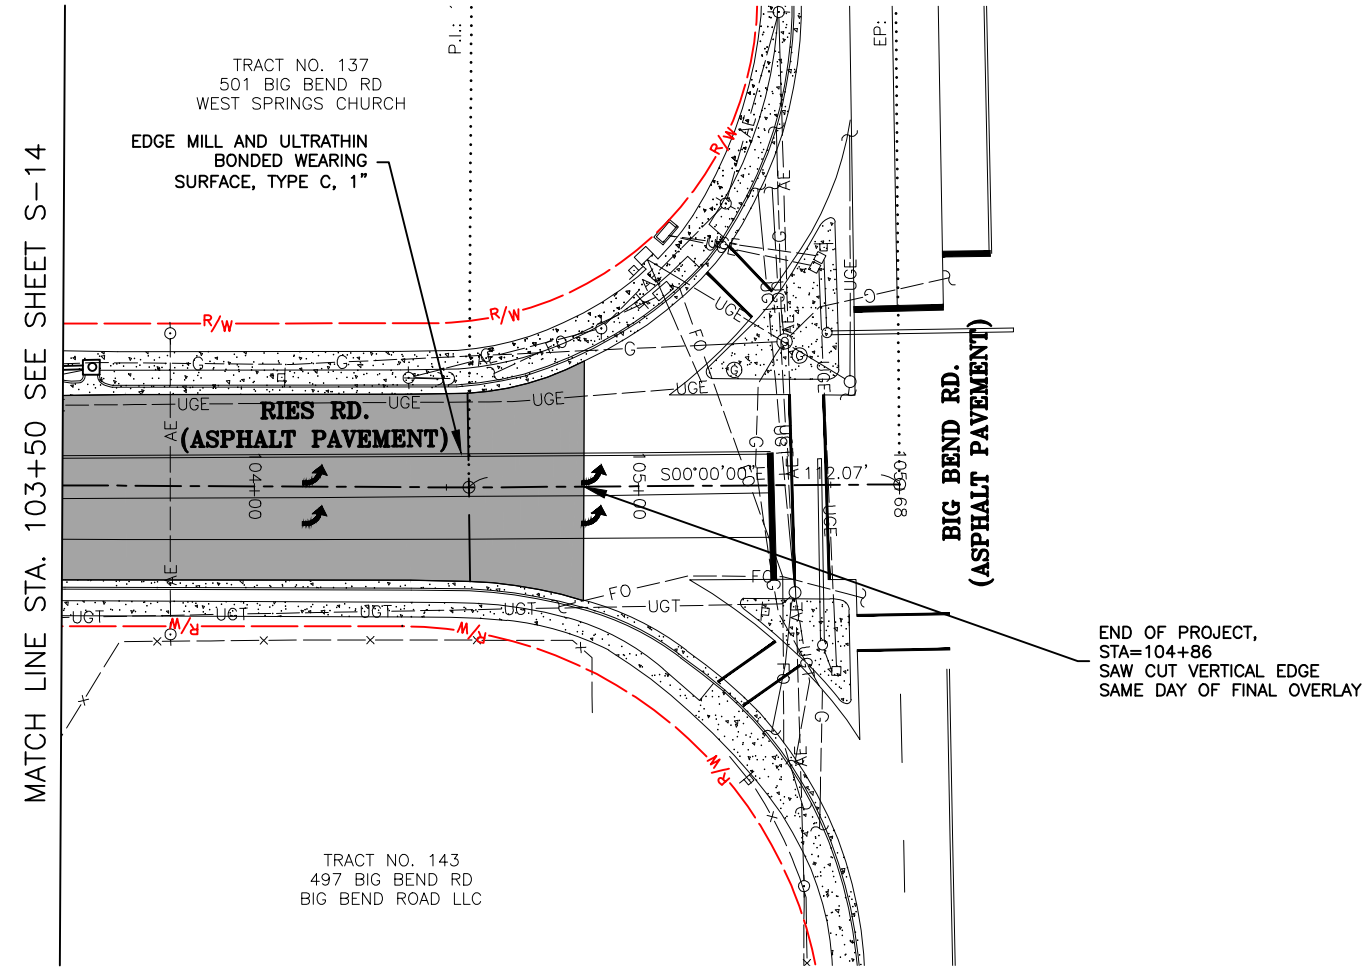
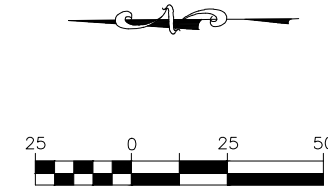
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RIES ROAD IMPROVEMENTS
FEDERAL PROJECT NO. STP-4939(610)
CITY OF BALLWIN, MISSOURI

DATE:	REVISION:
DWN. BY:	APP'D. BY:
M.D.M.	K.J.W.
DATE:	
10/6/23	
SCALE:	
1" = 50'	
PROJ. NO:	
SC19-1061	
DWG. NO:	
S-14	

SITE PLAN



MATCH LINE STA. 103+50 SEE SHEET S-14

TRACT NO. 137
501 BIG BEND RD
WEST SPRINGS CHURCH

EDGE MILL AND ULTRATHIN
BONDED WEARING
SURFACE, TYPE C, 1"

**RIES RD.
(ASPHALT PAVEMENT)**

**BIG BEND RD.
(ASPHALT PAVEMENT)**

TRACT NO. 143
497 BIG BEND RD
BIG BEND ROAD LLC

END OF PROJECT,
STA=104+86
SAW CUT VERTICAL EDGE
SAME DAY OF FINAL OVERLAY

Drawing name: J:\SC19-1061 Ballwin Ries Road\AUTOCAD DRAWINGS\SITE PLAN.dwg Tab: S-15 Plotted on: Oct 18, 2023 - 10:51am Plotted by: MSpalding

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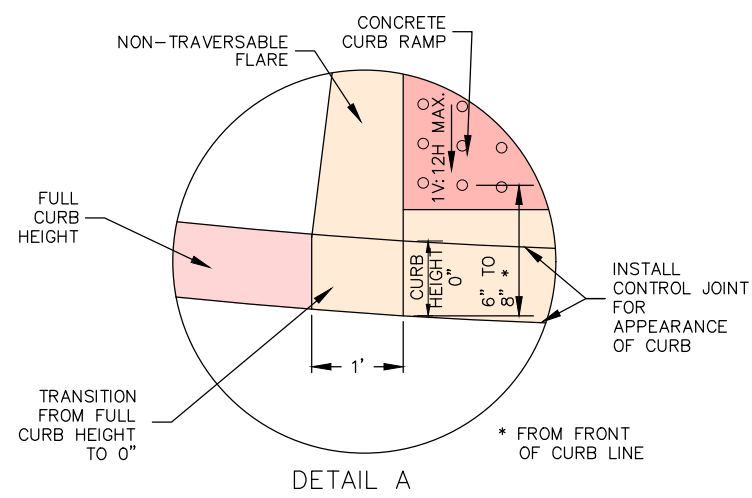
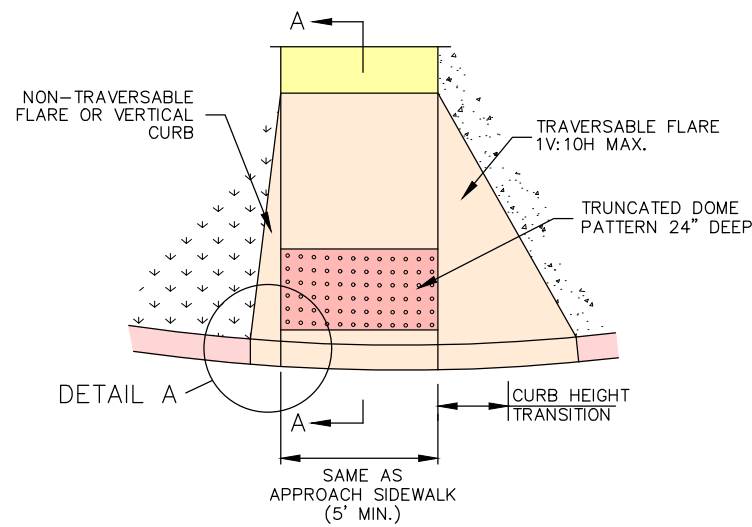
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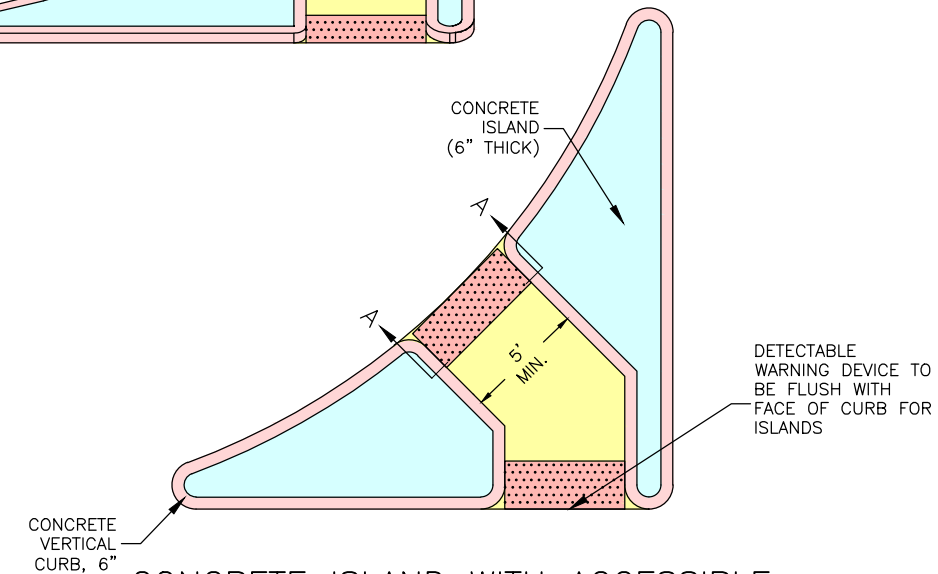
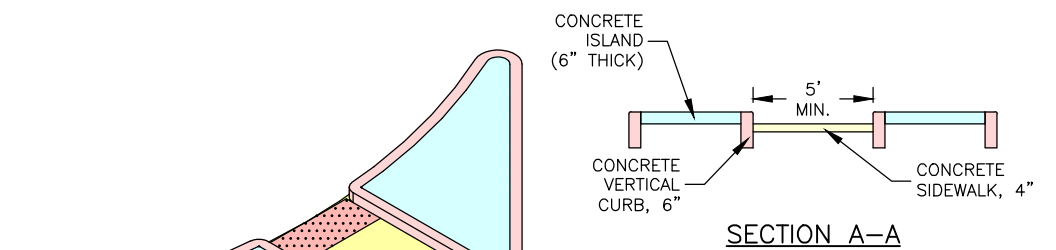
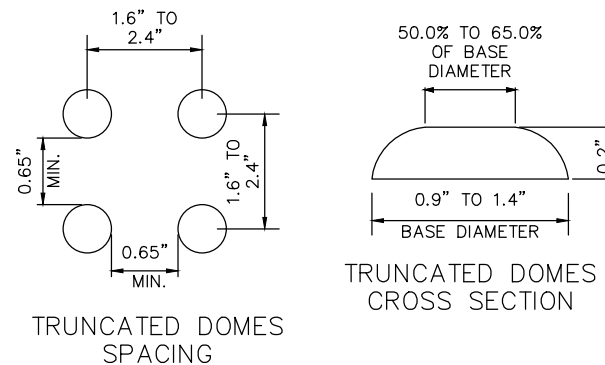
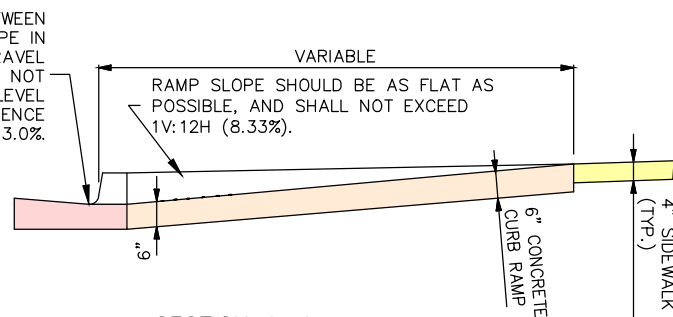
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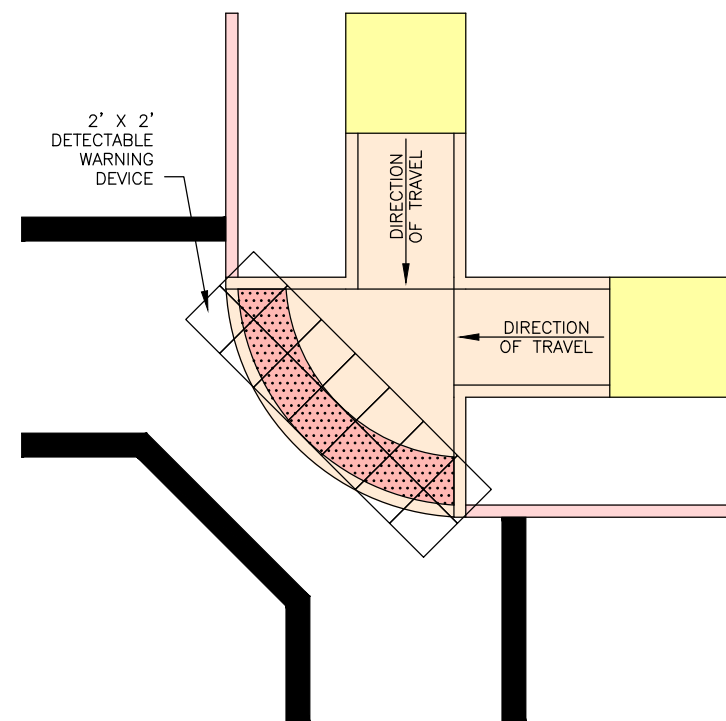
DATE:		REVISION:
DWN. BY:	APPD. BY:	
M.D.M.	K.J.W.	
DATE:		
10/6/23		
SCALE:		
1" = 50'		
PROJ. NO:		
SC19-1061		
DWG. NO:		
S-15		



ALGEBRAIC DIFFERENCE BETWEEN PAVEMENT OR GUTTER SLOPE IN DIRECTION OF PEDESTRIAN TRAVEL AND CURB RAMP SLOPE SHALL NOT EXCEED 13.0%. PROVIDE 24" LEVEL LANDING IF ALGEBRAIC DIFFERENCE EXCEEDS 13.0%.




CONCRETE ISLAND WITH ACCESSIBLE CUT-THROUGH DETAIL
NO SCALE



DETECTABLE WARNING DEVICE LAYOUT FOR 2 DIRECTION RAMP
NO SCALE


NOTES:

1. CONTRACTOR MUST TRIM THE DETECTABLE WARNING PANELS TO PROVIDE A 2' DEEP STRIP THAT IS THE FULL WIDTH OF THE RAMP AND FOLLOWS THE CURVATURE OF THE CURB.
2. 2' X 2' DETECTABLE WARNING PANEL IS FOR REFERENCE ONLY. CONTRACTOR MAY USE ALTERNATE SIZED PANELS TO MINIMIZE CUTTING.
3. THE DETECTABLE WARNING DEVICE LAYOUT FOR 1 DIRECTIONAL RAMP MUST BE USED WHEN THE "X" DIMENSION IS GREATER THAN 5 FEET. WHEN "X" IS LESS THAN 5 FEET, THE DETECTABLE WARNING DEVICES SHALL BE AT THE BOTTOM OF THE RAMP AND PARALLEL TO THE DIRECTION OF TRAVEL.

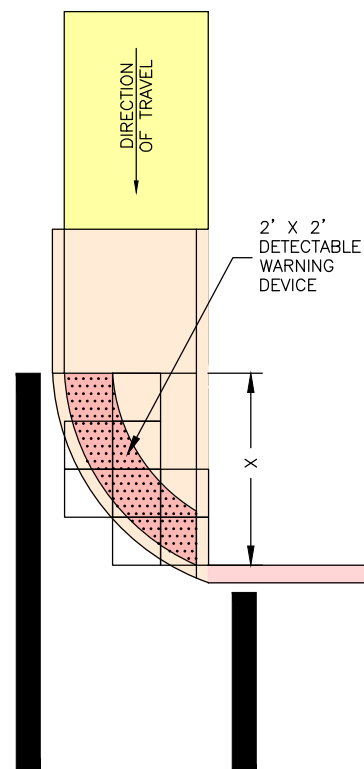


DETECTABLE WARNING DEVICE LAYOUT FOR 1 DIRECTION RAMP
NO SCALE

WHEN DISTANCE "X" IS LESS THAN 5', TRUNCATED DOME DETECTABLE WARNING DEVICE SHALL BE PLACED PERPENDICULAR TO THE PATH OF TRAVEL.

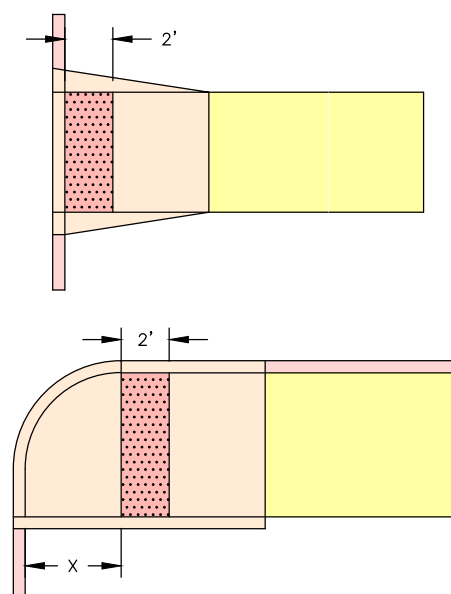



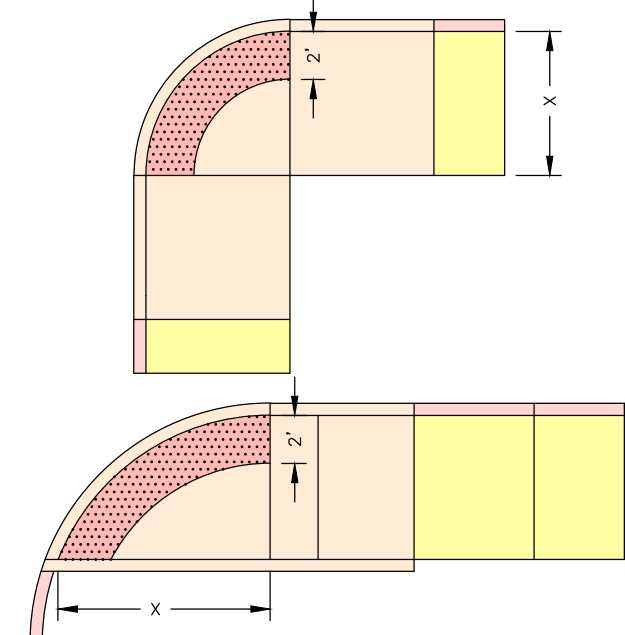

DETECTABLE WARNING DEVICE PLACEMENT ON RAMP
NO SCALE

WHEN DISTANCE "X" IS GREATER THAN 5', TRUNCATED DOME DETECTABLE WARNING DEVICE SHALL BE PLACED PARALLEL TO THE BOTTOM OF THE CURB RAMP.




LEGEND


-  1.0% MIN., 2.0% MAX. CROSS SLOPE.
-  LANDING AREA. MIN. 5' X 5' WITH 1.0% MIN., 2.0% MAX. SLOPE IN ANY DIRECTION.
-  MAX. RAMP SLOPE IS 1V:12H (8.33%) AND HAVE A CROSS SLOPE OF 1.0% MIN., 2.0% MAX.
-  DETECTABLE WARNING DEVICE. EXTEND 2' IN DIRECTION OF TRAVEL.

KEYED NOTES


- (1) 1' OR VERTICAL CURB AS DIRECTED BY THE ENGINEER. IF TRAVERSABLE, MAX. SLOPE IS 1V:10H WHEN MEASURED PARALLEL TO CURB LINE.
- (2) SEE PLAN SHEETS FOR WIDTH. SIDEWALKS AT CURB SHALL BE A MINIMUM OF 6' WIDE AND SIDEWALKS WITH A TREE LAWN SHALL BE A MINIMUM OF 5', WIDE UNLESS OTHERWISE APPROVED BY THE ENGINEER.
- (3) DETECTABLE WARNING DEVICES ARE NOT USED ON EVERY CURB RAMP INSTALLED. SEE SITE PLAN FOR LOCATIONS WITH DETECTABLE WARNING DEVICES.
- (4) TRANSITION AREA SLOPE TO BE MAXIMUM OF 5.0% OR MATCH STREET GRADE. SLOPES SHALL NOT CREATE AN AREA THAT HOLDS WATER.

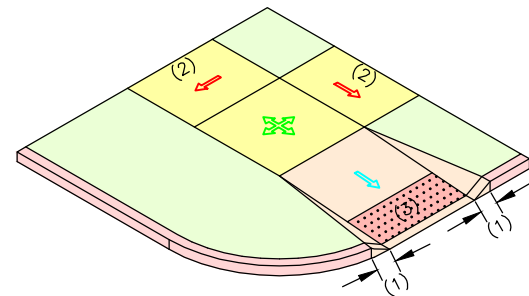

TYPE A1

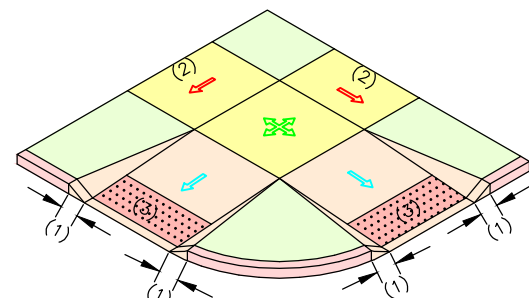


TYPE A2

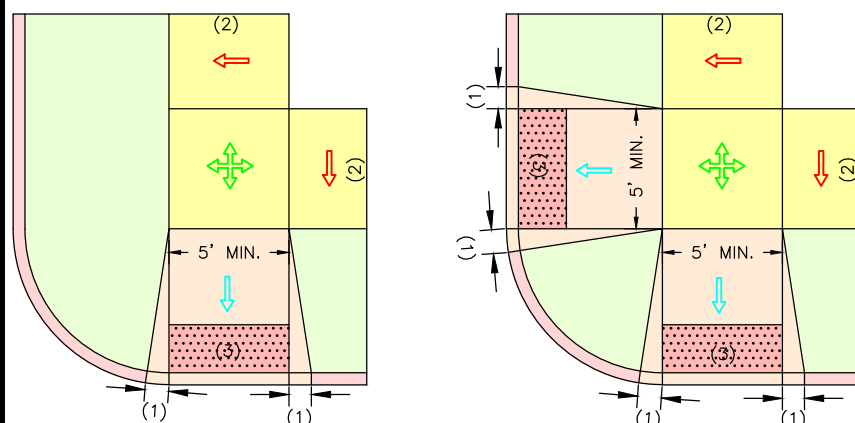


TYPE A1

TYPE A2


TYPE A1 AND A2 CURB RAMP PERPENDICULAR WITH TREE LAWN (6' OR GREATER)
NO SCALE

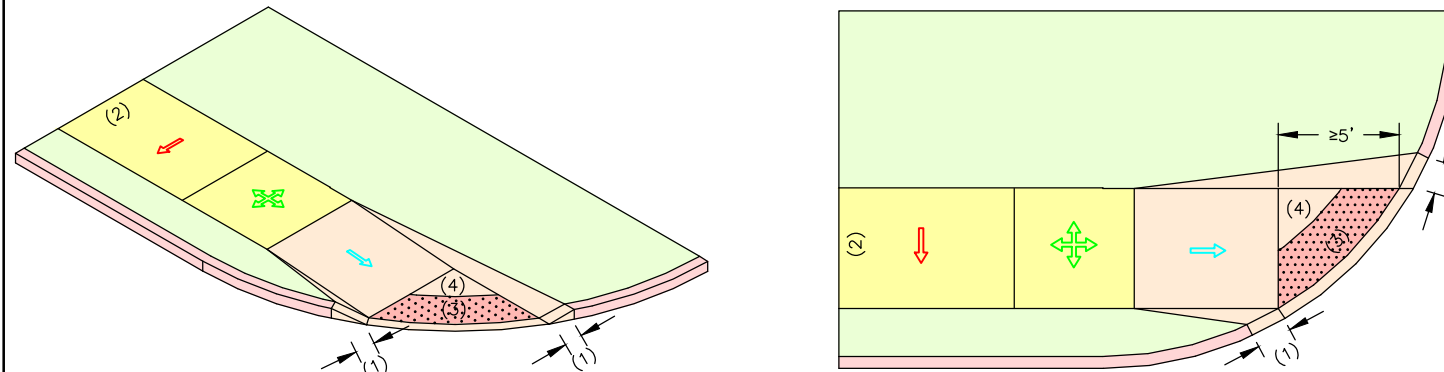

TYPE A3 CURB RAMP PERPENDICULAR WITH TREE LAWN LARGE RADIUS
NO SCALE

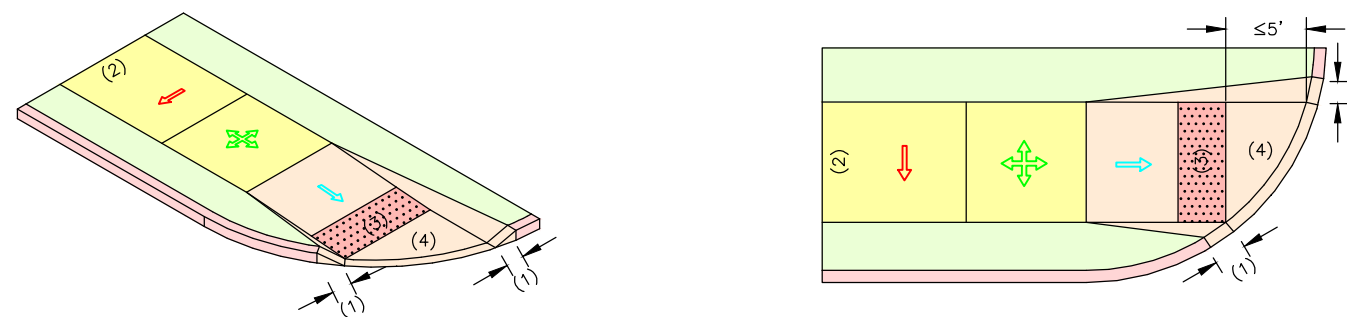

TYPE A4 CURB RAMP PERPENDICULAR WITH TREE LAWN, SMALL RADIUS
NO SCALE

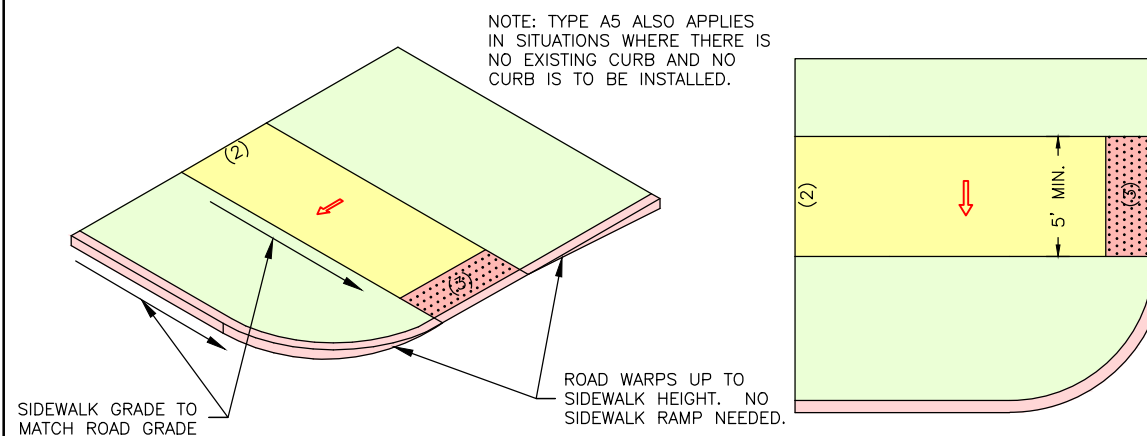

NOTE: TYPE A5 ALSO APPLIES IN SITUATIONS WHERE THERE IS NO EXISTING CURB AND NO CURB IS TO BE INSTALLED.

ROAD WARPS UP TO SIDEWALK HEIGHT. NO SIDEWALK RAMP NEEDED.

TYPE A5 CURB RAMP PERPENDICULAR WITH TREE LAWN, NO RAMP
NO SCALE

CURB RAMP GENERAL NOTES:

ALL AREAS OF THE PEDESTRIAN ACCESS ROUTE MUST BE COMPLIANT WITH THE "AMERICANS WITH DISABILITIES ACT ACCESSIBILITY GUIDELINES (ADAAG)". EXCEPTIONS MUST BE APPROVED BY THE ENGINEER.

FINISHED SIDEWALK SHALL BE STABLE, SLIP RESISTANT AND SURFACE DOES NOT POND WATER.

SIDEWALK AND RAMP CROSS SLOPES SHALL BE A MINIMUM OF 1.0% TO FACILITATE DRAINAGE AND A MAXIMUM OF 2.0% TO BE USABLE FOR DISABLED INDIVIDUALS.

STORMWATER INLETS, SIGNS, POSTS, MANHOLE COVERS, PULL BOXES AND OTHER ACCESS LIDS SHOULD BE AVOIDED WITHIN THE SIDEWALK. IF SUCH A LOCATION IS NECESSARY, THE FEATURE MUST MEET ADA STANDARDS.

THE RUNNING GRADE OF A SIDEWALK SHALL NOT EXCEED 5.0% UNLESS IT IS MATCHING THE GRADE OF THE ADJACENT ROADWAY.

ALL RAMP SLOPES SHALL NOT HAVE RUNNING SLOPES GREATER THAN 8.33% OR 1V:12H. RAMP LENGTH NOT REQUIRED TO EXCEED 15 FEET.

PEDESTRIAN ACCESS ROUTE SHALL CONTINUE ACROSS DRIVEWAYS.

LANDINGS SHALL BE CONSTRUCTED AT THE TOP AND/OR BOTTOM OF A CURB RAMP WHEREVER A TURNING MOVEMENT OR ACCESS TO PEDESTRIAN PUSH BUTTON IS REQUIRED.

LANDINGS LOCATED IN THE ROADWAY MUST BE COMPLETELY CONTAINED WITHIN THE CROSSWALK.

SIDE FLARES OF CURB RAMP, IN THE PATH OF PEDESTRIAN TRAVEL (TRAVERSABLE), SHALL NOT EXCEED A SLOPE OF 1V:10H. SIDE FLARES OUTSIDE THE PEDESTRIAN PATH (NONTRAVERSABLE) MAY BE 1V:2H OR VERTICAL.

TRANSITION FROM SIDEWALK TO GUTTER TO ROADWAY MUST BE FLUSH.

DETECTABLE WARNING DEVICE (TRUNCATED DOMES) SHALL BE PRE-FORMED AND INSTALLED AS PER MANUFACTURER'S RECOMMENDATIONS, AT PUBLIC STREET INTERSECTIONS AND ANY SIGNALIZED INTERSECTIONS. STAMPED CONCRETE WILL NOT BE ACCEPTED.

THE DETECTABLE WARNING DEVICE SHALL BE RED. TRUNCATED DOMES SHALL SPAN THE FULL WIDTH (WITHIN 2") OF THE RAMP OR LANDING.

DETECTABLE WARNING DOMES SHALL BE ALIGNED PARALLEL TO THE SLOPE WHEN INSTALLED ON A RAMP. WHEN INSTALLED ON A LANDING OR BLENDED TRANSITION, THEY SHALL BE ALIGNED PERPENDICULAR OR RADIAL TO THE BREAK BETWEEN THE RAMP, LANDING OR BLENDED TRANSITION AND THE STREET.

IF CONSTRUCTION OF 5' X 5' LANDING IS NOT FEASIBLE, 4' X 4' LANDING MAY BE USED WITH APPROVAL FROM THE ENGINEER.

RAMP WIDTH MAY BE REDUCED TO 4' WITH APPROVAL OF THE ENGINEER.

CURB RAMP AND INTEGRAL CURBS THAT ARE PART OF RAMP SHALL BE INCLUDED IN THE UNIT BID PRICE FOR CONCRETE SIDEWALK.

THE CONTRACTOR SHALL IDENTIFY THE REMOVAL LIMITS FOR THE SIDEWALK AND CURB. IF THE CONTRACTOR DETERMINES THE REMOVAL LIMITS ARE NOT ADEQUATE TO MEET ADA STANDARDS, THE CONTRACTOR SHALL STOP WORK IMMEDIATELY AND CONSULT THE ENGINEER TO DETERMINE THE BEST SOLUTION.

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


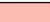
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RIES ROAD IMPROVEMENTS
FEDERAL PROJECT NO. STP-4939(610)
CITY OF BALLWIN, MISSOURI

SIDEWALK AND RAMP DETAILS

DATE:	REVISION:
DWN. BY:	APPD. BY:
M.D.M.	K.J.W.
DATE:	10/6/23
SCALE:	AS SHOWN
PROJ. NO.:	SC19-1061
DWG. NO.:	DE-3

LEGEND

-  1.0% MIN., 2.0% MAX. CROSS SLOPE.
-  LANDING AREA. MIN. 5' X 5' WITH 1.0% MIN., 2.0% MAX. SLOPE IN ANY DIRECTION.
-  MAX. RAMP SLOPE IS 1V:12H (8.33%) AND HAVE A CROSS SLOPE OF 1.0% MIN., 2.0% MAX.
-  DETECTABLE WARNING DEVICE. EXTEND 2' IN DIRECTION OF TRAVEL.

KEYED NOTES

- (1) VARIABLE CURB HEIGHT. CURB MAY BE ELIMINATED IF UNNECESSARY AND APPROVED BY THE ENGINEER.
- (2) TRANSITION AREA SLOPE TO BE MAXIMUM OF 5.0% OR MATCH STREET GRADE. SLOPES SHALL NOT CREATE AN AREA THAT HOLDS WATER.
- (3) SEE PLAN SHEETS FOR WIDTH. SIDEWALKS AT CURB SHALL BE A MINIMUM OF 6' WIDE AND SIDEWALKS WITH A TREE LAWN SHALL BE A MINIMUM OF 5', WIDE UNLESS OTHERWISE APPROVED BY THE ENGINEER.
- (4) FLARE MAX. SLOPE IS 1V:10H WHEN MEASURED PARALLEL TO CURB LINE.
- (5) ENSURE THAT INSIDE EDGE OF CURVED RAMPS MAINTAIN A 1V:12H (8.33%) MAX. SLOPE.
- (6) ENSURE ADEQUATE DRAINAGE OF LANDING AREA. SLOPES SHALL NOT CREATE A LANDING AREA THAT HOLDS WATER.
- (7) 1' WIDE FLARE MAY BE SUBSTITUTED FOR VERTICAL CURB AT THE DISCRETION OF THE ENGINEER FOR NO ADDITION COST.
- (8) DETECTABLE WARNING DEVICES ARE NOT USED ON EVERY CURB RAMP INSTALLED. SEE SITE PLAN FOR LOCATIONS WITH DETECTABLE WARNING DEVICES.

CURB RAMP GENERAL NOTES:

ALL AREAS OF THE PEDESTRIAN ACCESS ROUTE MUST BE COMPLIANT WITH THE "AMERICANS WITH DISABILITIES ACT ACCESSIBILITY GUIDELINES (ADAAG)". EXCEPTIONS MUST BE APPROVED BY THE ENGINEER.

FINISHED SIDEWALK SHALL BE STABLE, SLIP RESISTANT AND SURFACE DOES NOT POND WATER.

SIDEWALK AND RAMP CROSS SLOPES SHALL BE A MINIMUM OF 1.0% TO FACILITATE DRAINAGE AND A MAXIMUM OF 2.0% TO BE USABLE FOR DISABLED INDIVIDUALS.

STORMWATER INLETS, SIGNS, POSTS, MANHOLE COVERS, PULL BOXES AND OTHER ACCESS LIDS SHOULD BE AVOIDED WITHIN THE SIDEWALK. IF SUCH A LOCATION IS NECESSARY, THE FEATURE MUST MEET ADA STANDARDS.

THE RUNNING GRADE OF A SIDEWALK SHALL NOT EXCEED 5.0% UNLESS IT IS MATCHING THE GRADE OF THE ADJACENT ROADWAY.

ALL RAMPS SHALL NOT HAVE RUNNING SLOPES GREATER THAN 8.33% OR 1V:12H. RAMP LENGTH NOT REQUIRED TO EXCEED 15 FEET.

PEDESTRIAN ACCESS ROUTE SHALL CONTINUE ACROSS DRIVEWAYS.

LANDINGS SHALL BE CONSTRUCTED AT THE TOP AND/OR BOTTOM OF A CURB RAMP WHEREVER A TURNING MOVEMENT OR ACCESS TO PEDESTRIAN PUSH BUTTON IS REQUIRED.

LANDINGS LOCATED IN THE ROADWAY MUST BE COMPLETELY CONTAINED WITHIN THE CROSSWALK.

SIDE FLARES OF CURB RAMPS, IN THE PATH OF PEDESTRIAN TRAVEL (TRAVERSABLE), SHALL NOT EXCEED A SLOPE OF 1V:10H. SIDE FLARES OUTSIDE THE PEDESTRIAN PATH (NONTRAVERSABLE) MAY BE 1V:2H OR VERTICAL.

TRANSITION FROM SIDEWALK TO GUTTER TO ROADWAY MUST BE FLUSH.

DETECTABLE WARNING DEVICE (TRUNCATED DOMES) SHALL BE PRE-FORMED AND INSTALLED AS PER MANUFACTURER'S RECOMMENDATIONS, AT PUBLIC STREET INTERSECTIONS AND ANY SIGNALIZED INTERSECTIONS. STAMPED CONCRETE WILL NOT BE ACCEPTED.

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RAMP WIDTH MAY BE REDUCED TO 4' WITH APPROVAL OF THE ENGINEER.

CURB RAMPS AND INTEGRAL CURBS THAT ARE PART OF RAMPS SHALL BE INCLUDED IN THE UNIT BID PRICE FOR CONCRETE SIDEWALK.

THE CONTRACTOR SHALL IDENTIFY THE REMOVAL LIMITS FOR THE SIDEWALK AND CURB. IF THE CONTRACTOR DETERMINES THE REMOVAL LIMITS ARE NOT ADEQUATE TO MEET ADA STANDARDS, THE CONTRACTOR SHALL STOP WORK IMMEDIATELY AND CONSULT THE ENGINEER TO DETERMINE THE BEST SOLUTION.

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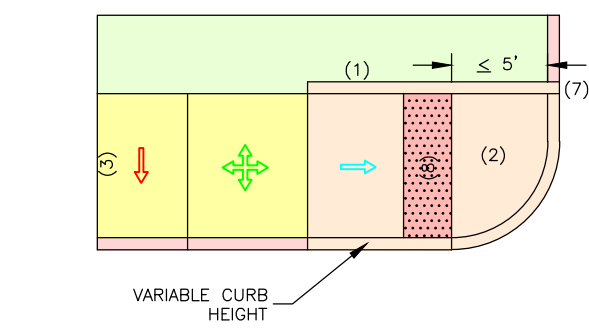
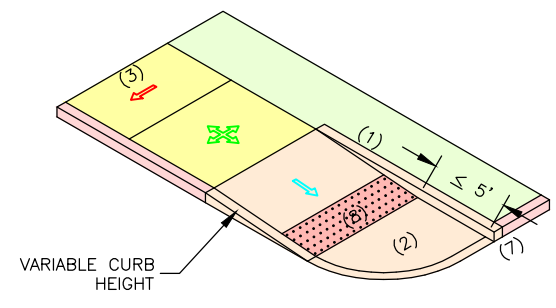
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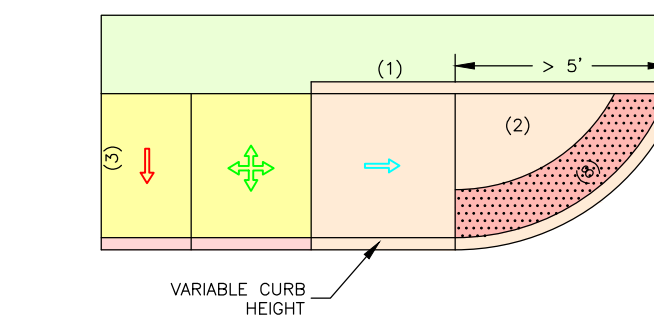
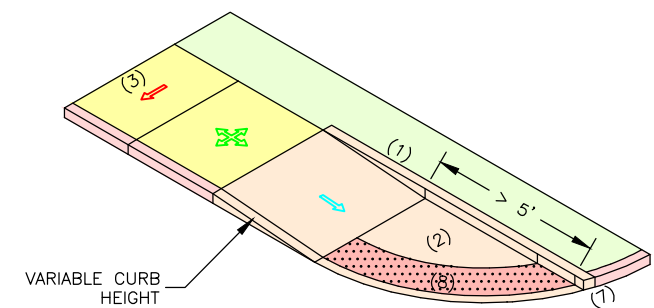
RIES ROAD IMPROVEMENTS
FEDERAL PROJECT NO. STP-4939(610)
CITY OF BALLWIN, MISSOURI

SIDEWALK AND RAMP DETAILS



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DWN. BY:	APPD. BY:
M.D.M.	K.J.W.
DATE:	
10/6/23	
SCALE:	
AS SHOWN	
PROJ. NO.:	
SC19-1061	
DWG. NO.:	
DE-5	




TYPE C1 CURB RAMP
PERPENDICULAR SMALL RADIUS
NO SCALE




TYPE C2 CURB RAMP
PERPENDICULAR LARGE RADIUS
NO SCALE

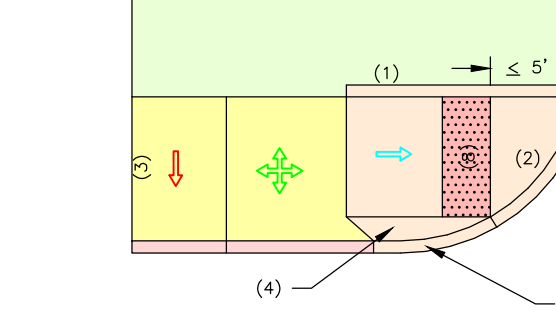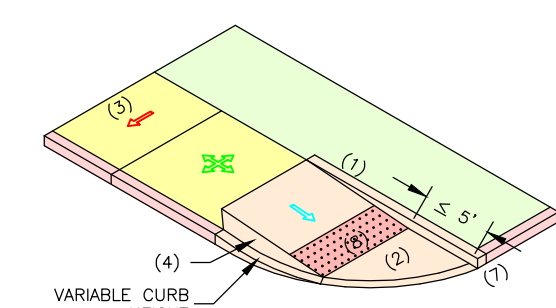

TYPE C3 CURB RAMP
PERPENDICULAR WITH TRAVERSABLE FLARE
NO SCALE

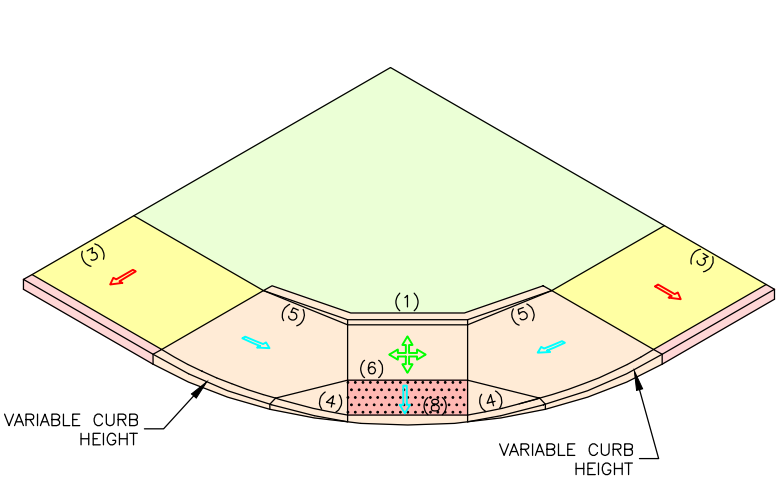



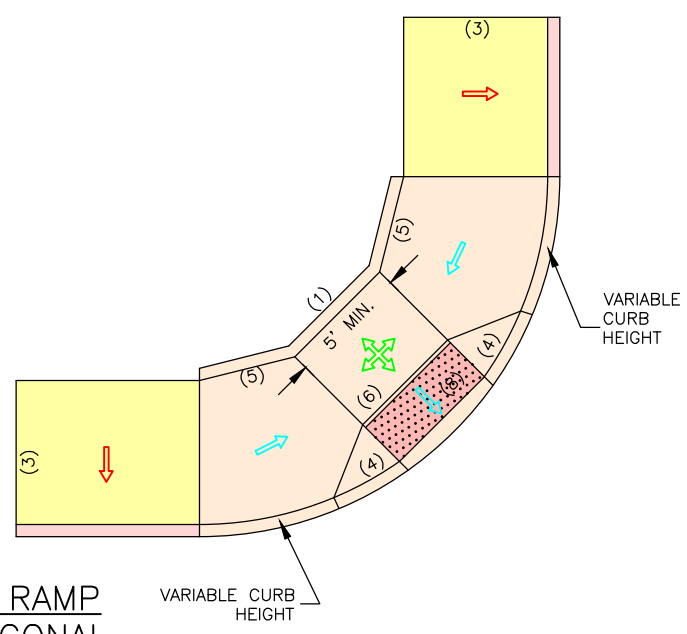

TYPE D CURB RAMP
COMPOUND DIAGONAL
NO SCALE




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LEGEND


-  1.0% MIN., 2.0% MAX. CROSS SLOPE.
-  LANDING AREA. MIN. 5' X 5' WITH 1.0% MIN., 2.0% MAX. SLOPE IN ANY DIRECTION.
-  MAX. RAMP SLOPE IS 1V:12H (8.33%) AND HAVE A CROSS SLOPE OF 1.0% MIN., 2.0% MAX.
-  DETECTABLE WARNING DEVICE. EXTEND 2' IN DIRECTION OF TRAVEL.

KEYED NOTES


- (1) VARIABLE CURB HEIGHT. CURB MAY BE ELIMINATED IF UNNECESSARY AND APPROVED BY THE ENGINEER.
- (2) SEE PLAN SHEETS FOR WIDTH. SIDEWALKS AT CURB SHALL BE A MINIMUM OF 6' WIDE AND SIDEWALKS WITH A TREE LAWN SHALL BE A MINIMUM OF 5' WIDE UNLESS OTHERWISE APPROVED BY THE ENGINEER.
- (3) FLARE MAX. SLOPE IS 1V:10H WHEN MEASURED PARALLEL TO CURB LINE.
- (4) ENSURE ADEQUATE DRAINAGE OF LANDING AREA. SLOPES SHALL NOT CREATE A LANDING AREA THAT HOLDS WATER.
- (5) ENSURE THAT INSIDE EDGE OF CURVED RAMPS MAINTAIN A 1V:12H (8.33%) MAX. SLOPE.
- (6) DETECTABLE WARNING DEVICES ARE NOT USED ON EVERY CURB RAMP INSTALLED. SEE SITE PLAN FOR LOCATIONS WITH DETECTABLE WARNING DEVICES.

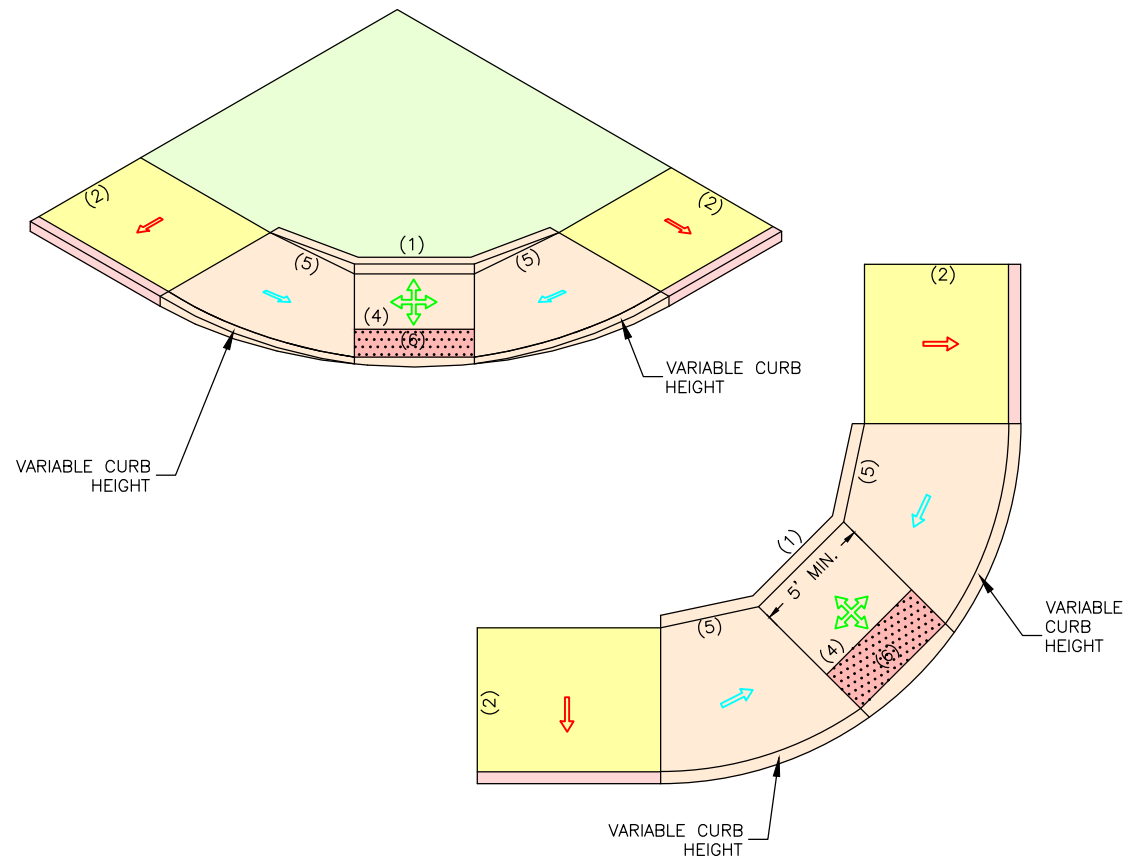


TYPE E1 CURB RAMP
PARALLEL DIAGONAL FOR NARROW
SIDEWALKS, LARGE RADIUS
 NO SCALE

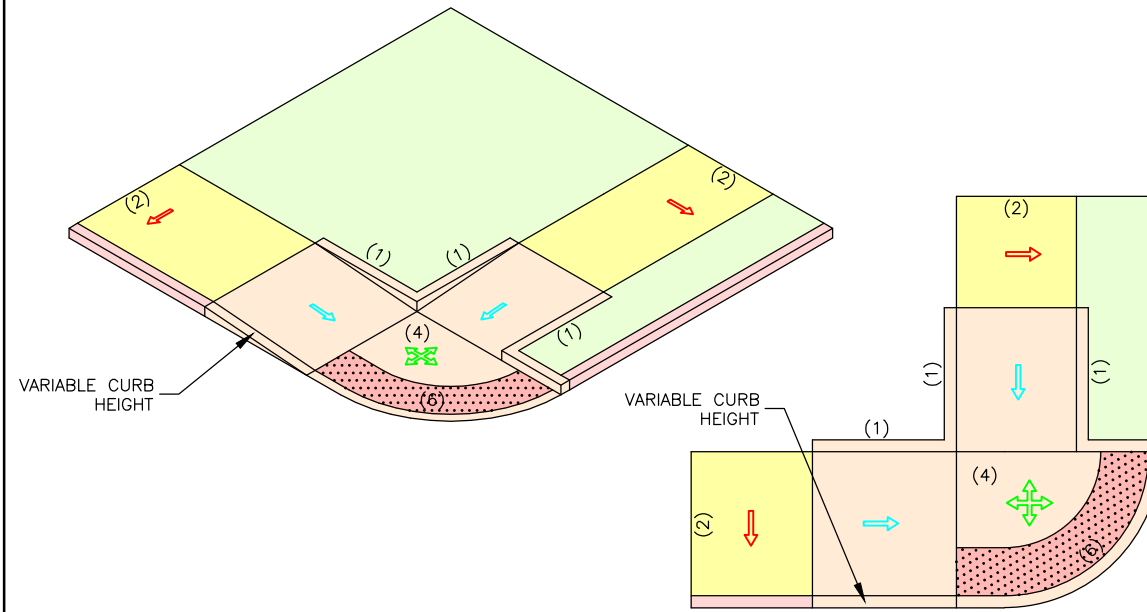

TYPE E3 CURB RAMP
PARALLEL DIAGONAL FOR NARROW SIDEWALKS,
SMALL RADIUS, ONE TREE LAWN
 NO SCALE

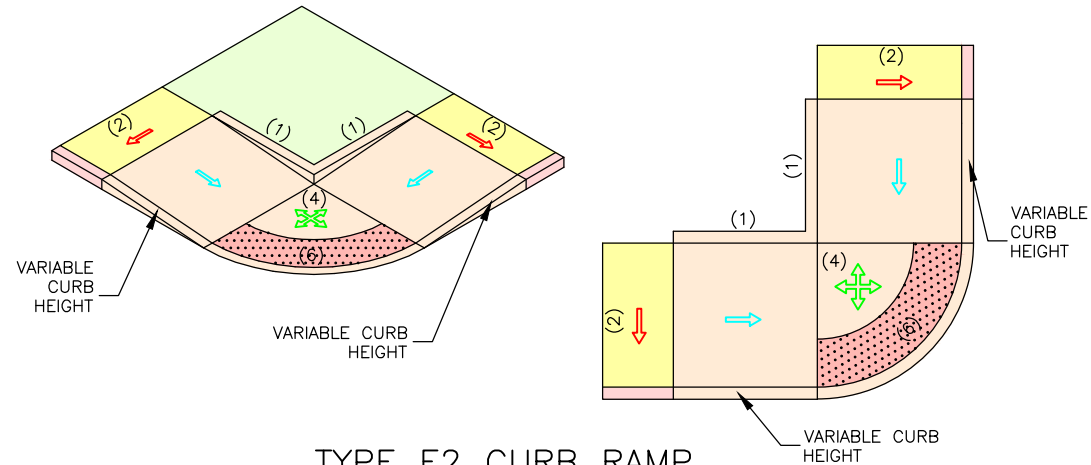

TYPE E2 CURB RAMP
PARALLEL DIAGONAL FOR NARROW
SIDEWALKS, SMALL RADIUS, NO TREE LAWN
 NO SCALE

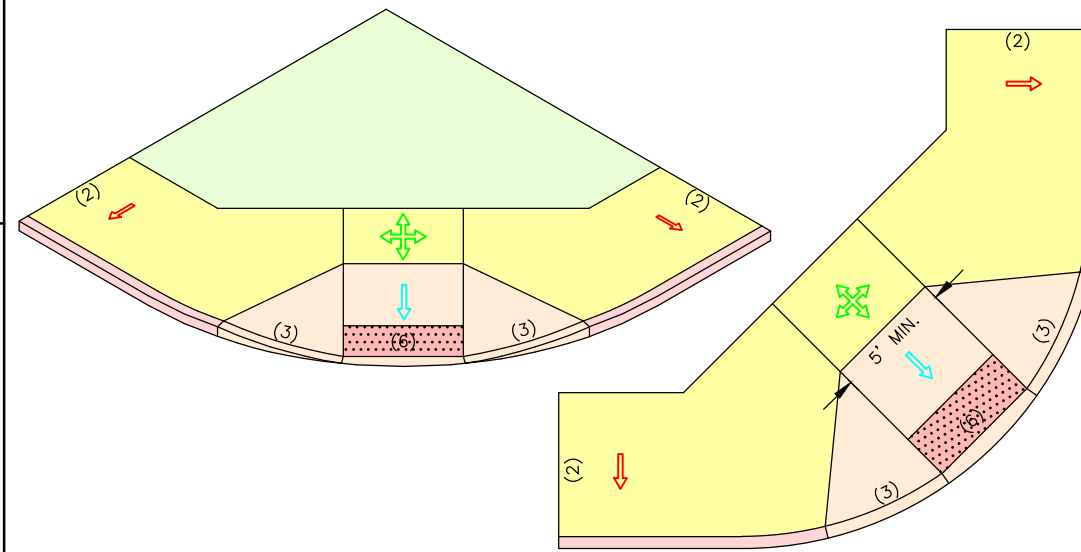

TYPE F1 CURB RAMP
DIAGONAL FOR NARROW SIDEWALKS
 NO SCALE

CURB RAMP GENERAL NOTES:

ALL AREAS OF THE PEDESTRIAN ACCESS ROUTE MUST BE COMPLIANT WITH THE "AMERICANS WITH DISABILITIES ACT ACCESSIBILITY GUIDELINES (ADAAG)". EXCEPTIONS MUST BE APPROVED BY THE ENGINEER.

FINISHED SIDEWALK SHALL BE STABLE, SLIP RESISTANT AND SURFACE DOES NOT POND WATER.

SIDEWALK AND RAMP CROSS SLOPES SHALL BE A MINIMUM OF 1.0% TO FACILITATE DRAINAGE AND A MAXIMUM OF 2.0% TO BE USABLE FOR DISABLED INDIVIDUALS.

STORMWATER INLETS, SIGNS, POSTS, MANHOLE COVERS, PULL BOXES AND OTHER ACCESS LIDS SHOULD BE AVOIDED WITHIN THE SIDEWALK. IF SUCH A LOCATION IS NECESSARY, THE FEATURE MUST MEET ADA STANDARDS.

THE RUNNING GRADE OF A SIDEWALK SHALL NOT EXCEED 5.0% UNLESS IT IS MATCHING THE GRADE OF THE ADJACENT ROADWAY.

ALL RAMPS SHALL NOT HAVE RUNNING SLOPES GREATER THAN 8.33% OR 1V:12H. RAMP LENGTH NOT REQUIRED TO EXCEED 15 FEET.

PEDESTRIAN ACCESS ROUTE SHALL CONTINUE ACROSS DRIVEWAYS.

LANDINGS SHALL BE CONSTRUCTED AT THE TOP AND/OR BOTTOM OF A CURB RAMP WHEREVER A TURNING MOVEMENT OR ACCESS TO PEDESTRIAN PUSH BUTTON IS REQUIRED.

LANDINGS LOCATED IN THE ROADWAY MUST BE COMPLETELY CONTAINED WITHIN THE CROSSWALK.

SIDE FLARES OF CURB RAMPS, IN THE PATH OF PEDESTRIAN TRAVEL (TRAVERSABLE), SHALL NOT EXCEED A SLOPE OF 1V:10H. SIDE FLARES OUTSIDE THE PEDESTRIAN PATH (NONTRAVERSABLE) MAY BE 1V:2H OR VERTICAL.

TRANSITION FROM SIDEWALK TO GUTTER TO ROADWAY MUST BE FLUSH.

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IF CONSTRUCTION OF 5' X 5' LANDING IS NOT FEASIBLE, 4' X 4' LANDING MAY BE USED WITH APPROVAL FROM THE ENGINEER.

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 FENTON, MISSOURI 63026

ENGINEERING CERTIFICATE OF AUTHORITY NUMBER - 2007006937
 LAND SURVEYING CERTIFICATE OF AUTHORITY NUMBER - 2007004529

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



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RIES ROAD IMPROVEMENTS
FEDERAL PROJECT NO. STP-4939(610)
CITY OF BALLWIN, MISSOURI

SIDEWALK AND RAMP DETAILS

DATE:	REVISION:
DWN. BY:	APPD. BY:
M.D.M.	K.J.W.
DATE:	
10/6/23	
SCALE:	
AS SHOWN	
PROJ. NO.:	
SC19-1061	
DWG. NO.:	
DE-6	

LEGEND

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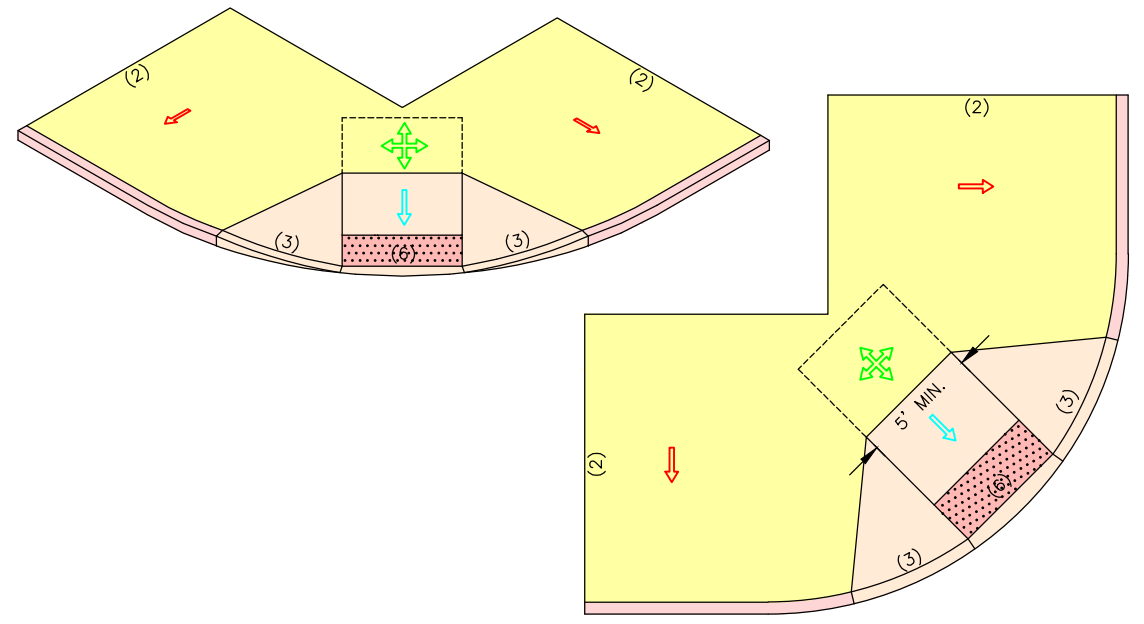
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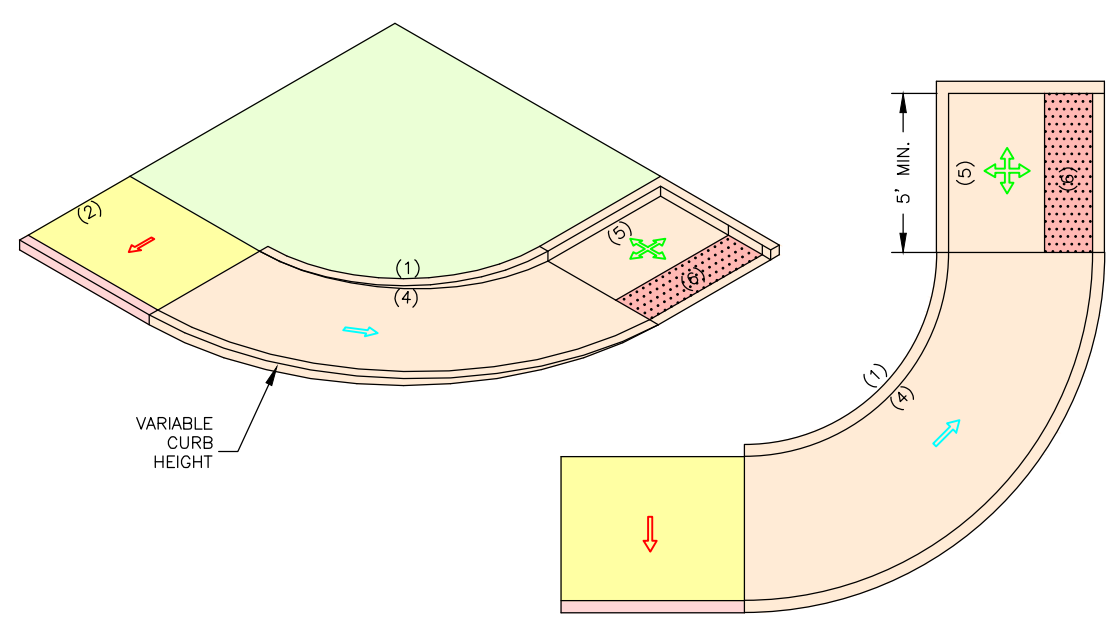
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SIDEWALK AND RAMP DETAILS


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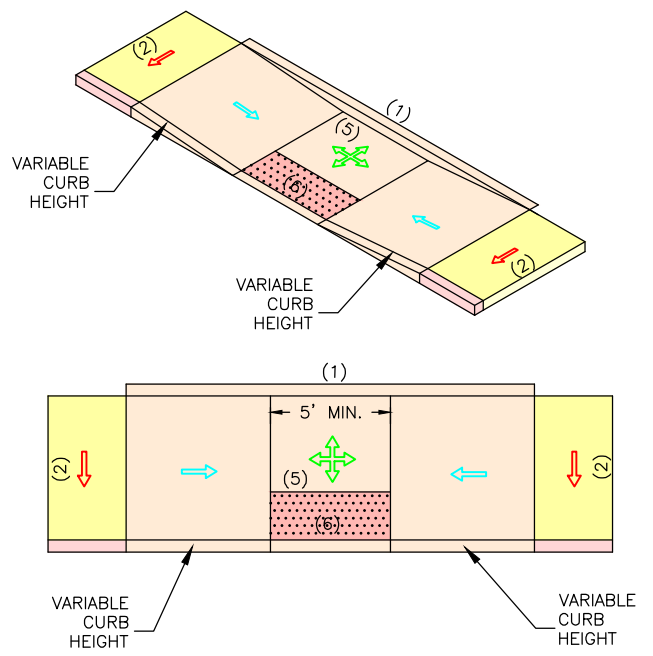
TYPE F2 CURB RAMP
DIAGONAL FOR WIDE SIDEWALKS
NO SCALE



TYPE G1 CURB RAMP
PARALLEL AT INTERSECTION
NO SCALE



TYPE G2 CURB RAMP
PARALLEL, CHANGING DIRECTION
NO SCALE

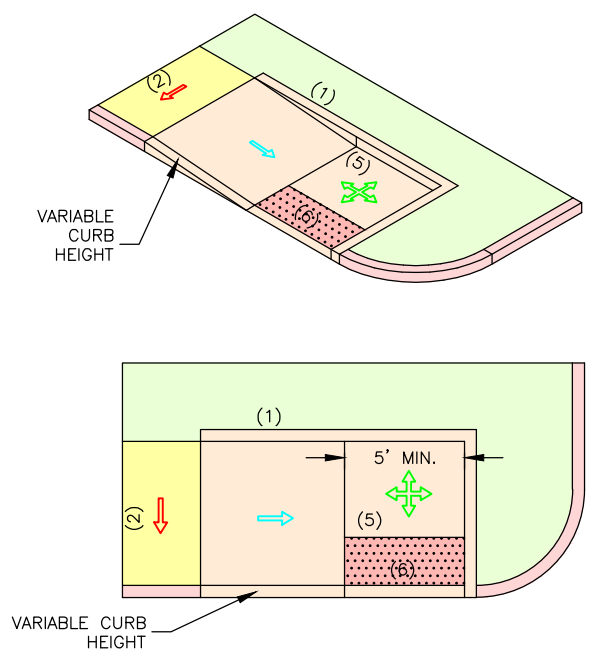

TYPE G3 CURB RAMP
PARALLEL, MIDBLOCK
NO SCALE

